


# Report

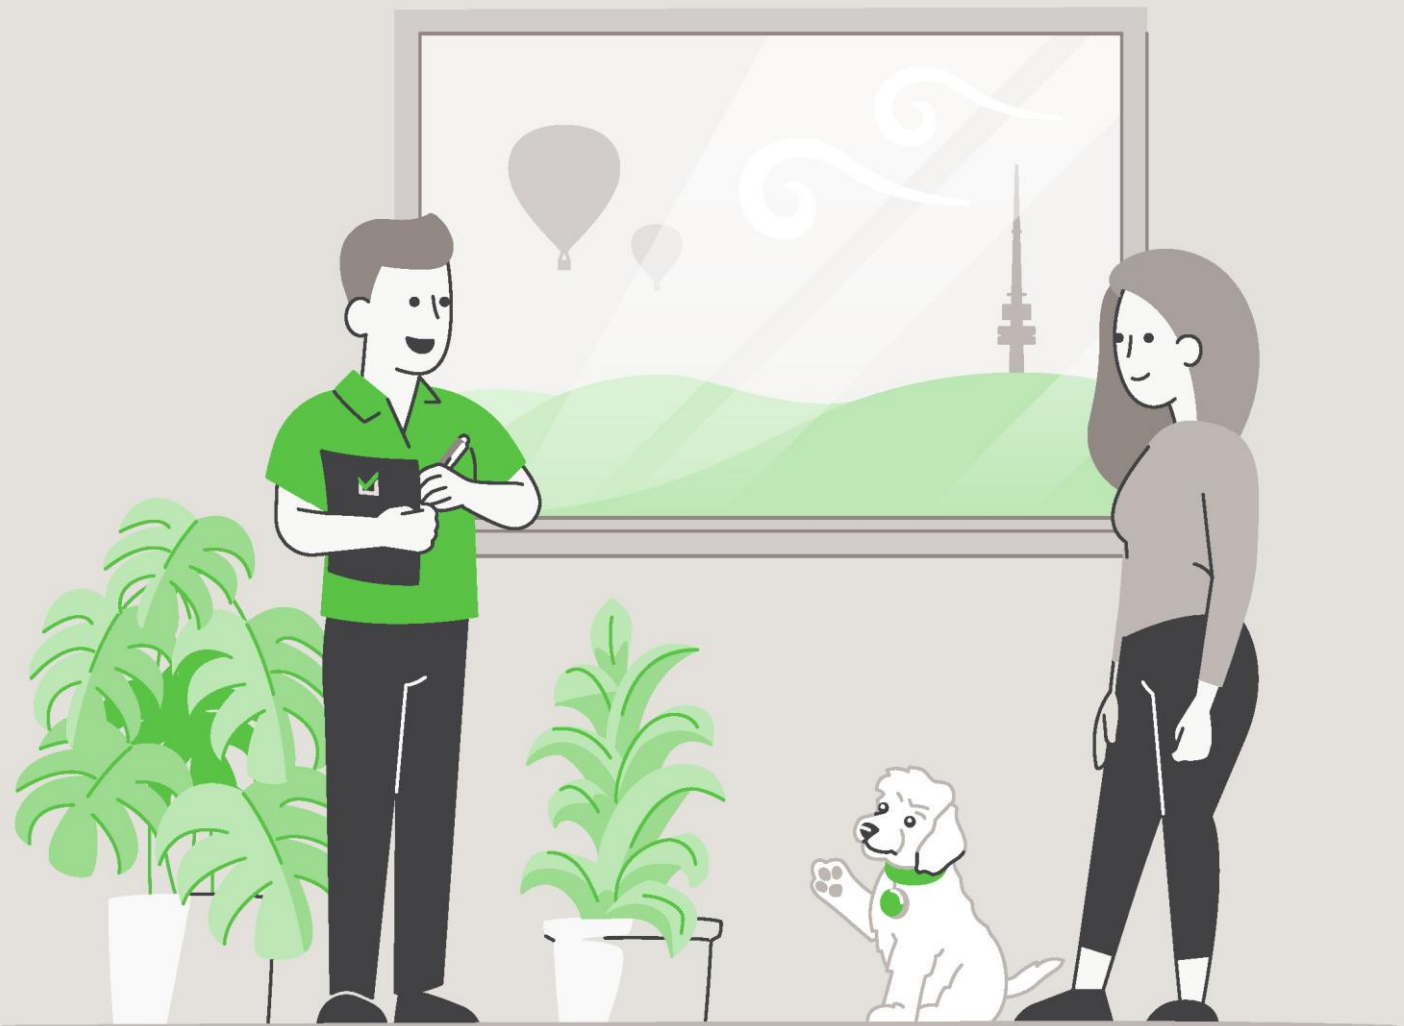

## LIMITED LIABILITY TO A PURCHASER WITHIN THE AUSTRALIAN CAPITAL TERRITORY


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This Report is made solely for the use and benefit of the Client. The Consultant is not liable for any reliance placed on this report by any third party. However, within the ACT only and in accordance with the Civil Law (Sale of Residential Property) Act 2003 and the Civil Law (Sale of Residential Property) Regulations 2004, a copy of the report must be attached to the Contract for Sale and may in certain circumstances be relied upon by the Purchaser of residential property.

The circumstances in which a Purchaser of residential property within the ACT may rely on this report in respect of the state of the property at the time of the inspection are as follows:

- (a)** The inspection was carried out no earlier than three months before the day the property was first advertised or offered for sale or listed by an agent; and
- (b)** The date on which the contract was entered into was not more than 180 days after the date of the inspection.
- (c)** The report is provided to the Purchaser prior to or at the time the Contract for Sale is entered into between the Purchaser and vendor.
- (d)** The service requested is the Standard Inspection Report.

# Building Report

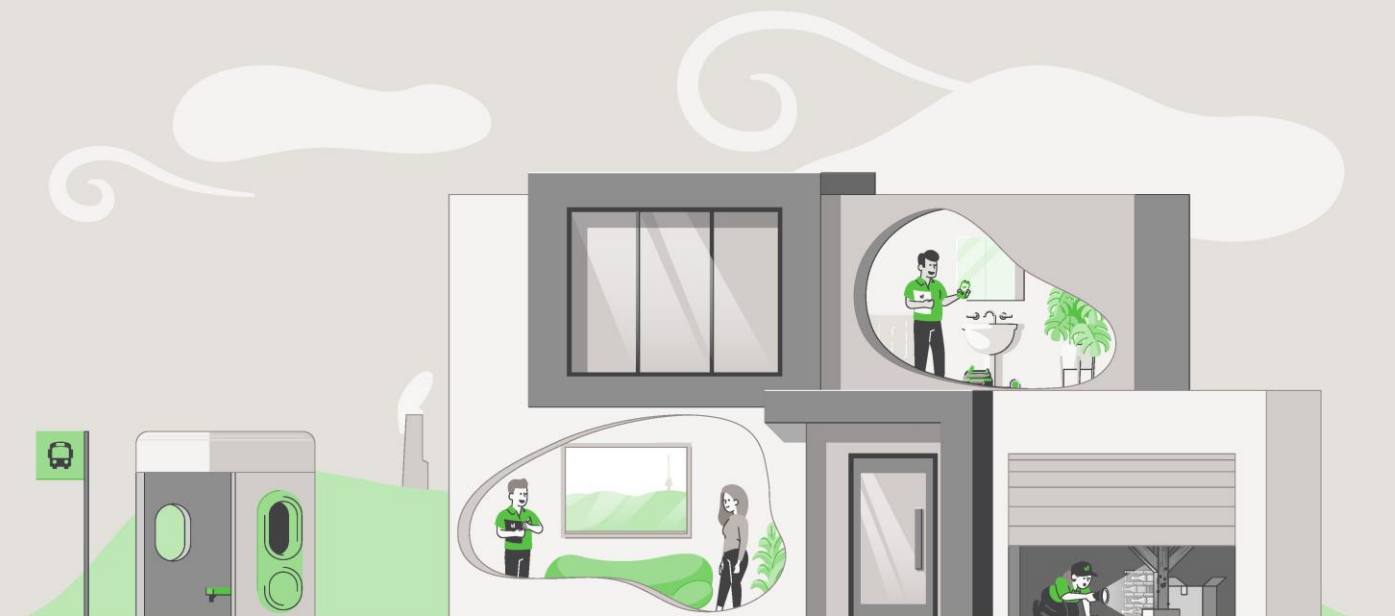

## CONCLUSION AND SUMMARY

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The purpose of the Inspection is to identify the major defects and safety hazards associated with the property at the time of the Inspection. The Inspection and reporting are limited to a visual assessment of the Building Members in accord with Appendix C AS4349.1-2007.

The overall condition of this building has been compared to similar constructed buildings of approximately the same age where those buildings have had a maintenance program implemented to ensure that the building members are still fit for purpose.

**The incidence of Major Defects** in this Residential Building as compared with similar Buildings is considered: **Medium**

**The incidence of Minor Defects** in this Residential Building as compared with similar Buildings is considered: **Medium**

**The overall condition** of this Residential Dwelling in the context of its age, type and general expectations of similar properties is: **Average**

**Please Note:** This is a general appraisal only and cannot be relied upon on its own – read the Report in its entirety.

This Summary is supplied to allow a quick and superficial overview of the Inspection results. This Summary is NOT the Report and cannot be relied upon on its own. This Summary must be read in conjunction with the full Report and not in isolation from the Report. If there should happen to be any discrepancy between anything in the Report and anything in this Summary, the information in the Report shall override that in this Summary.

**PROPERTY STATISTICS**


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Building Report	Average
Compliance Report	Please read full compliance report section of the report
Pest Inspection	No active subterranean termites (live specimen) were found
Energy Efficiency Rating	4.0 Stars
Inspection Date	Thursday, February 26 <sup>th</sup> 2026
Name of Assessor	Dylan Mitchell
Reference Number	68451
Address of Property Inspected	34 Malara St, Waramanga ACT 2611
Client	McSkimming
Block and Section	Block 4 Section 8 WARAMANGA
Year original residence COU was issued	1970
Block size (approximately)	781m <sup>2</sup>
House size (approximately)	Residence: 109.69m <sup>2</sup> Garage: 58.50m <sup>2</sup> Carport (original front pergola): 37.00m <sup>2</sup>
Weather conditions at time of Inspection	Fine - Previous rain
Occupancy Status	Occupied

\*The table above is to be used as a quick reference. Please read the full Report before reaching your conclusion regarding the condition of the Property.

Whilst every care has been taken to ensure the accuracy of the property house and block size, we accept no responsibility for any inaccuracies as supplying this information exceeds a standard building inspection under AS4349.1-2007.

## PROPERTY CONSTRUCTION DETAILS

Flooring	Timber bearers and joists
External walls	Brick veneer
Roof framing	Timber: Truss roof framing
Roof cladding	Concrete roof tiles
Glazing	Single glazed windows
Cooktop	Electric cooktop
Oven	Electric oven
Dishwasher	AEG

\*Whilst every care has been taken to ensure the accuracy of the property construction details, we accept no responsibility for any inaccuracies of construction details or testing of appliances.

## GENERAL ACCESS LIMITATIONS

Internal	At the time of inspection, the building was furnished. This allows for a limited inspection in areas not restricted by furnishings, stored goods, floor mats, etc.
External	Inspection was limited in areas around the fence line due to vegetation restricting access. No inspection was made to sections of the residence and/or structures built on the side boundary
Roof void	NOTE. Inspection around the eaves was restricted due to low pitch and clearance to allow bodily access in this area. This allows only for a limited visual inspection from a distance to be carried out. Other restrictions found in the roof void: Insulation on top of ceiling restricting visual inspection of the ceiling framing. Ducting flex throughout the roof space restricting access in areas
Subfloor	A full inspection was carried out in the subfloor
On-top of roof	The inspection was restricted to visually looking from a 3.6m ladder lent against the gutter in several areas around the building
Garage	The inspection of the garage was restricted due to stored goods being kept in the area at the time of inspection

\*Where access is noted as limited or restricted, it is recommended that access be gained to these areas as these areas may contain concealed defects.

**DEFINITIONS**

<b>Good</b>	The item is in the Inspector's opinion of an acceptable standard with no defects visible. Superficial defects will not be commented on
<b>Fair</b>	The item in the Inspector's opinion has some minor defects and requires minimal maintenance or repair
<b>Poor</b>	The item in the Inspector's opinion needs significant repair or replacement

**ENTRANCE/HALLWAY**

Ceiling	Minor cracking was noted to the cornice joints. Repairs are optional
Walls	Minor cracking was noted around the door. This is caused through normal building movement and is not considered to be excessive cracking
Door and door hardware	Minor cosmetic damage noted to the base of the door. Repairs are considered optional
Floor coverings	Good

**KITCHEN/DINING/LIVING**

Ceiling	Good
Walls	Good
Door and door hardware	Good
Floor coverings	Good
Kitchen cupboards	Good
Bench top	Good
Splashback	Good
Exhaust fan	The exhaust fan was operational at the time of inspection

**BEDROOM 1**

Ceiling	Minor cracking was noted in the ceiling. This is caused through normal building movement and is not considered to be excessive cracking
Walls	Minor cracking was noted above the door. This is caused through normal building movement and is not considered to be excessive cracking
Door and door hardware	The striker plate on the door jamb needs adjustment to allow the door to latch
Floor coverings	Good
Wardrobe	Good

**BEDROOM 2**

Ceiling	Good
Walls	Good
Door and door hardware	Good
Floor coverings	Good
Wardrobe	Good

**BEDROOM 3**

Ceiling	Good
Walls	Minor cracking was noted above the door. This is caused through normal building movement and is not considered to be excessive cracking
Door and door hardware	The striker plate on the door jamb needs adjustment to allow the door to latch
Floor coverings	Good
Wardrobe	Good

**BATHROOM**

Ceiling	Good
Walls	Minor cracking was noted above the door. This is caused through normal building movement and is not considered to be excessive cracking
Door and door hardware	Good
Floor coverings	Good
Shower screen	Good
Water leakage in shower area?	An inspection from under the floor indicated that the shower is leaking. Recommend repairs by a qualified tradesperson
Vanity/Basin	Good
Taps	Good
Bath	Good. Minor chips noted
Toilet suite	Good
Exhaust fan	The exhaust fan was operational at the time of inspection

**LAUNDRY**

Ceiling	Good
Walls	Good
Door and door hardware	Good
Floor coverings	Good
Laundry tub	Good
Splashback	Good
Exhaust fan	An exhaust fan is not installed. If a dryer is installed, we recommend installation of a suitable exhaust fan

**ROOF CAVITY**

Construction	Good
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**SUBFLOOR**

Subfloor soil conditions	The subfloor soil was generally dry at the time of inspection
Ventilation	Generally adequate
Floor structure	Areas of water staining and minor decay were noted to the flooring under the bathroom, likely associated with the shower leak. Repairs to the floor were not required at the time of inspection
Access door to subfloor area	Fair

**GARAGE**

Roof covering	The metal roof covering is in typical condition for a structure of this age, with signs of corrosion evident. Recommend treating the corrosion to extend the life span of the roof covering. Damage noted to the polycarbonate roof sections. Repairs are required
Gutters	Areas of the gutters are blocked from leaf debris. The gutters would overflow during rainfall. Recommend clearing debris and monitoring during rainfall
Slab	Good. Some minor cracking of the concrete was noted. The cracking found is considered normal
Walls	Good
Garage door	Good/Fair
Access door	Good/Fair

**EXTERIOR**

Driveway and paths	Several areas of cracking and movement noted in the exterior concrete. The cracking and movement found is typical for a home of this age
Roof covering	Several chipped tiles were noted on the roof. This is unlikely to cause a leak due to the overlap in the tiles
Roof pointing	The roof pointing is generally good; however, there are some areas of minor cracking/flaking
Eaves	The eave lining is in fair condition with areas requiring general maintenance/repairs
Fascia	Areas of general weathering and timber decay noted in several end sections of the timber fascia. General repairs would extend the lifespan of the timbers
Gutters	The gutters are in need of repairs/replacement
External walls	Moderate cracking noted in areas of the external walls. The cracking is likely to have been caused by building settlement. If ongoing movement is noted, recommend further review by a structural engineer. Sections of unfinished brickwork noted to the rear sliding door. Repairs are required
Windows	The rubber sill flashing at the bottom of several external windows has deteriorated, due to external weathering. Recommend repairs by a window specialist There are several gaps between the windows and the external walls. Consideration should be given to installing trims/flashings to these areas
Fences	Areas of the timber fence are in need of general repairs and maintenance
Gate	Good
Rear pergola	Timber decay and weathering noted to the timbers. Repairs are recommended
Front pergola (carport)	Damage noted to the roof covering. Replacement is recommended. Weathering and minor decay was noted to the timbers. Regular maintenance/painting is recommended
Retaining walls	Some movement was noted in the retaining walls. The walls are still retaining the ground behind the wall adequately. Apart from monitoring, no action is required
Site drainage	The site generally drains away from the perimeter of the building

## DEFINITIONS

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**Above Average:** The overall condition is above that consistent with dwellings of approximately the same age and construction. Most items and areas are well maintained and show a reasonable standard of workmanship when compared with buildings of similar age and construction.

**Average:** The overall condition is consistent with dwellings of approximately the same age and construction. There will be areas or items requiring some repair or maintenance.

**Below Average:** The Building and its parts show some significant defects and/or very poor non-tradesman like workmanship and/or long-term neglect and/or defects requiring major repairs or reconstruction of major building elements.

**Client:** The person or persons, for whom the Inspection Report was carried out or their Principal (i.e., the person or persons for whom the report is being obtained).

**Building Consultant:** A person, business or company who is qualified and experienced to undertake a pre-purchase inspection in accordance with Australian Standard AS 4349.1-2007 'Inspection of Buildings. Part 1: Pre-Purchase Inspections – Residential Buildings'. The consultant must also meet any Government licensing requirement, where applicable.

**Building & Site:** The inspection of the nominated residence together with relevant features including any car accommodation, detached laundry, ablution facilities and garden sheds, retaining walls more than 700 mm high, paths and driveways, steps, fencing, earth, embankments, surface water drainage and storm water run-off within 30 m of the building, but within the property boundaries. In the case of strata and company title properties, the inspection is limited to the interior and immediate exterior of the nominated residence and does not include inspection of common property.

**Readily Accessible Areas:** Areas which can be easily and safely inspected without injury to person or property, are up to 3.6 metres above ground or floor levels or accessible from a 3.6 metre ladder, in roof spaces where the minimum area of accessibility is not less than 600 mm high by 600 mm wide and subfloor spaces where the minimum area of accessibility is not less than 400 mm high by 600 mm wide, providing the spaces or areas permit entry. Or where these clearances are not available, areas within the consultant's unobstructed line of sight and within arm's length.

**Structure:** The loadbearing part of the building, comprising the Primary Elements.

**Primary Elements:** Those parts of the building providing the basic loadbearing capacity to the Structure, such as foundations, footings, floor framing, loadbearing walls, beams, or columns. The term 'Primary Elements' also includes other structural building elements including those that provide a level of personal protection such as handrails; floor-to-floor access such as stairways; and the structural flooring of the building such as floorboards.

**Secondary Elements:** Those parts of the building not providing loadbearing capacity to the Structure, or those non-essential elements which, in the main, perform a completion role around openings in Primary Elements and the building in general such as non-loadbearing walls, partitions, wall linings, ceilings, chimneys, flashings, windows, glazing or doors.

**Finishing Elements:** The fixtures, fittings and finishes applied or affixed to Primary Elements and Secondary Elements such as baths, water closets, vanity basins, kitchen cupboards, door furniture, window hardware, render, floor, and wall tiles, trim or paint. The term 'Finishing Elements' does not include furniture or soft floor coverings such as carpet and lino.

**Major Defect:** A defect of significant magnitude where rectification has to be carried out in order to avoid unsafe conditions, loss of utility or further deterioration of the property.

**Minor Defect:** A defect other than a Major Defect.

**Safety Hazard:** Any item that may constitute an immediate or imminent risk to life, health, or property. Occupational, health and safety or any other consequence of these hazards has not been assessed.

**Tests:** Where appropriate the carrying out of tests using the following procedures and instruments:

Dampness Tests means additional attention to the visual examination was given to those accessible areas which the consultant's experience has shown to be particularly susceptible to damp problems. Instrument testing using electronic moisture detecting meter of those areas and other visible accessible elements of construction showing evidence of dampness was performed.

Physical Tests means the following physical actions undertaken by the consultant: opening and shutting of doors, windows and draws; operation of taps; water testing of shower recesses; and the tapping of tiles and wall plaster.

## IMPORTANT ADVICE

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**NB.** In the case of strata and company title properties, the Inspection is limited to the interior and immediate exterior of the particular unit being inspected. The exterior above ground floor level is not inspected. The complete Inspection of other common property areas would be the subject of a Special-Purpose Inspection Report which is adequately specified.

**Trees:** Where trees are too close to the house this could affect the performance of the footing as the moisture levels change in the ground. A Geotechnical Inspection can determine the foundation material and provide advice on the best course of action with regards to the trees.

**The Septic Tanks:** Should be inspected by a licensed plumber.

**Swimming Pools:** Swimming Pools/Spas are not part of the Standard Building Report under AS4349.1-2007 and are not covered by this Report. We strongly recommend a pool expert should be consulted to examine the pool and the pool equipment and plumbing, as well as the requirements to meet the standard for pool fencing. Failure to conduct this Inspection and put into place the necessary recommendations could result in finds for non-compliance under the legislation.

**Surface Water Drainage:** The retention of water from surface run off could have an effect on the foundation material which in turn could affect the footings to the house. Best practice is to monitor the flow of surface water during rainfall and stormwater runoff and have the water directed away from the house or to storm water pipes by a licensed plumber/drainier.

**Weep Holes:** External brick (and stone) walls are a porous material that behave much like a sponge. During a rain event, the masonry wall absorbs water and actually stores it. The weep holes are designed for two purposes. 1. To provide an opening to allow water to drain out through the bottom of the wall. 2. To allow ventilating air to enter behind the wall to help dry the structure. If weep holes have been noted as being not installed, it is recommended to consult a builder on how to best rectify the problem.

**Water Leaks from Roof:** The inspector cannot, and does not, offer an opinion on whether the roof currently leaks or may be subject to future leaks. The only way to determine whether a roof is absolutely watertight is to make observations during prolonged rainfall.

**Subfloor dampness:** The presence of dampness is not always consistent as the prevailing and recent weather conditions at the time an inspection is carried out may affect the detection of damp problems. The absence of any dampness at the time of inspection does not necessarily mean the building will not experience some damp problems in other weather conditions. Likewise, whether or not services have been used for some time prior to an inspection being carried out will affect the detection of dampness.

**Shower:** Where a shower recess has been water tested, and no leakage was evident, this does not necessarily mean that the shower will not leak after prolonged use. Accordingly, to fully detect and assess a damp problem may require the monitoring of the building over a period of time.

## SCOPE AND LIMITATIONS

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**Any person who relies upon the contents of this Report does so acknowledging that the following clauses, which define the Scope and Limitations of the Inspection, form an integral part of the Report.**

**1) This Report is not an all-encompassing** Report dealing with the building from every aspect. It is a reasonable attempt to identify any obvious or significant defects apparent at the time of the Inspection. Whether or not a defect is considered significant or not, depends to a large extent upon the age and type of the building inspected. This Report is not a Certificate of Compliance with the requirements of any Act, Regulation, Ordinance or By-law. It is not a structural Report. Should you require any advice of a structural nature you should contact a structural engineer.

**2) This is a visual Inspection only**, limited to those areas and sections of the property fully accessible and visible to the Inspector on the date of Inspection. The Inspection DID NOT include breaking apart, dismantling, removing, or moving objects including, but not limited to, foliage, mouldings, roof insulation/sisalation, floor or wall coverings, sidings, ceilings, floors, furnishings, appliances, or personal possessions. The inspector CANNOT see inside walls, between floors, inside skillion roofing, behind stored goods in cupboards and other areas that are concealed or obstructed. The inspector DID NOT dig, gouge, force or perform any other invasive procedures. Visible timbers CANNOT be destructively probed or hit without the written permission of the property owner.

**3) This Report does not and cannot make comment upon:** Defects that may have been concealed; the assessment or detection of defects (including rising damp and leaks) which may be subject to the prevailing weather conditions; whether or not services have been used for some time prior to the Inspection and whether this will affect the detection of leaks or other defects (e.g. In the case of shower enclosures the absence of any dampness at the time of the inspection does not necessarily mean that the enclosure will not leak); the presence or absence of timber pests; gas-fittings; common property areas; environmental concerns; the proximity of the property to flight paths, railways, or busy traffic; noise levels; health and safety issues; heritage concerns; security concerns; fire protection; site drainage (apart from **surface** water drainage); swimming pools and spas (non-structural); detection and identification of illegal building work; detection and identification of illegal plumbing work; durability of exposed finishes; neighbourhood problems; document analysis; electrical installation; any matters that are solely regulated by statute; any area(s) or item(s) that could not be inspected by the consultant.

Accordingly, this Report is NOT a guarantee that defects and/or damage does not exist in any inaccessible or partly inaccessible areas or sections of the property.

**NB.** Such matters may, upon request, be covered under the terms of a 'Special-Purpose Property Report'.

**4) Consumer Complaints Procedure:** In the event of any dispute or claim arising out of, or relating to the Inspection or the Report, you must notify us as soon as possible of the dispute or claim by email, fax, or mail. You must allow us (which includes persons nominated by us) to visit the property (which visit must occur within twenty eight (28) days of your notification to us) and give us full access in order that we may fully investigate the complaint. You will be provided with a written response to your dispute or claim within twenty-eight (28) days of the date of the Inspection.

If you are not satisfied with our response, you must within twenty one (21) days of your receipt of our written response, refer the matter to a Mediator nominated by us from the Institute of Arbitrators and Mediators of Australia. The cost of the Mediator will be borne equally by both parties, and as agreed as part of the mediated settlement.

Should the dispute or claim not be resolved by mediation, then the dispute or claim will proceed to arbitration. The Institute of Arbitrators and Mediators of Australia will appoint an Arbitrator who will hear and resolve the dispute. The arbitration, subject to any directions of Arbitrator, will proceed in the following manner:

**(a)** The parties must submit all written submissions and evidence to the Arbitrator within twenty one (21) days of the appointment of the Arbitrator; and

**(b)** The arbitration will be held within twenty one (21) days of the Arbitrator receiving the written submissions.

The Arbitrator will make a decision determining the dispute or claim within twenty one (21) of the final day of the arbitration. The Arbitrator may, as part of his determination, determine what costs, if any, each of the parties are to pay and the time by which the parties must be paid any settlement or costs.

The decision of the Arbitrator is final and binding on both parties. Should the Arbitrator order either party to pay any settlement amount or costs to the other party but not specify a time for payment, then such payment shall be made within twenty one (21) days of the order.

**NB.** In the event that you do not comply with the above Complaints Procedure and commence litigation against us, then you agree to fully indemnify us against any awards, costs, legal fees, and expenses incurred by us in having your litigation set aside or adjourned to permit the foregoing Complaints Procedure to complete.

**5) Asbestos Disclaimer: “No Inspection for Asbestos was carried out at the property, and no Report on the presence or absence of Asbestos is provided”.**

Buildings built prior to 1982 may have wall and/or ceiling sheeting, and other products including roof sheeting that contains Asbestos. Even buildings built after this date, up until the early 90s, may contain some Asbestos. Sheeting should be fully sealed. If you are concerned, the building was built prior to 1990, or if asbestos is noted as present within the property, then you should seek advice from a qualified asbestos removal expert as to the amount and importance of the asbestos present and the cost of sealing or removal. Drilling, cutting, or removing sheeting or products containing Asbestos is a high risk to peoples’ health. You should seek advice from a qualified asbestos removal expert.

**6) Mould (Mildew and non-wood decay fungi) Disclaimer:** Mildew and non-wood decay fungi are commonly known as mould. However, mould and their spores may cause health problems or allergic reactions, such as asthma and dermatitis in some people. No Inspection for mould was carried out at the property, and no Report on the presence or absence of mould is provided. If mould is noted as present within the property, or if you notice mould and you are concerned as to the possible health risk resulting from its presence, then you should seek advice from your local Council, State or Commonwealth Government Health Department, or a qualified expert such as an Industry Hygienist.

**7) Magnesite Flooring Disclaimer:** No Inspection for Magnesite Flooring was carried out at the property, and no Report on the presence or absence of Magnesite Flooring is provided. You should ask the owner whether Magnesite Flooring is present and/or seek advice from a Structural Engineer.

**8) Estimating Disclaimer:** Any estimates provided in this Report are merely opinions of possible costs that could be encountered, based on the knowledge and experience of the inspector, and are not estimates in the sense of being a calculation of the likely costs to be incurred. The estimates are NOT a guarantee or quotation for work to be carried out. The actual cost is ultimately dependent upon the materials used, standard of work carried out, and what a contractor is prepared to do the work for. It is recommended in ALL instances that multiple independent quotes are sourced prior to any work being carried out. The inspector accepts no liability for any estimates provided throughout this Report.

**9) Note:** If the Client has any doubt about the purpose, scope, and acceptance criteria on which the Report was based please discuss your concerns with the Consultant on receipt of the Report. The Client acknowledges that, unless stated otherwise, the Client as a matter of urgency should implement any recommendation or advice given in this Report.

## IMPORTANT DISCLAIMER

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**Disclaimer Liability:** No Liability shall be accepted on an account of failure of the Report to notify any problems in the area(s) or section(s) of the subject property physically inaccessible for Inspection, or to which access for Inspection is denied by or to the Inspector (including but not limited to or any area(s) or section(s) so specified by the Report).

**Disclaimer of Liability to Third Parties:** Compensation will only be payable for losses arising in contract or tort sustained by the Client named on the front of this Report. Any third party acting or relying on this Report, in whole or in part, does so entirely at their own risk. However, if ordered by a Real Estate Agent or a Vendor for the purpose of auctioning a property, then the Inspection Report may be ordered up to seven (7) days prior to the auction, copies may be given out prior to the auction and the Report will have a life of 14 days during which time it may be transferred to the purchaser. Providing the purchaser agrees to the terms of this agreement, then they may rely on the Report subject to the terms and conditions of this agreement and the Report itself.

**NB.** In the ACT under the Civil Law (Sale of Residential Property) Act 2003 and Regulations, the Report resulting from this Inspection may be passed to the purchaser as part of the sale process, providing it is carried out no more than three months prior to listing and is not more than six months old.

**Limited Liability to a Purchaser within the Australian Capital Territory only:** Within the Australian Capital Territory (ACT) and in accordance with the ACT Civil Law (Sale of Residential Property) Act 2003 and Regulations, a copy of the Report may be attached to the Contract for Sale.

**WARNING:** The Purchaser is advised that this Report reflects the condition of the property existing at the time of the Inspection (Inspection Date) and may not reflect the current state. It is, therefore, very strongly recommended that you promptly arrange for another Inspection and Report in accordance with Australian Standard AS4349.1 to be carried out prior to the expiration of the 'Cooling off Period' and settlement.

**This is not a Compliance Report strictly in accordance with Civil Law (Sale of Residential Property) Regulations:** The Report may contain copies of any approved plans, building approvals, building permit and Certificates of Occupancy. However, any comments made by the person who prepared the Report as to whether or not, in the opinion of the Inspector, the structures on the land substantially comply with the approved plans (if any) are made on the basis of a cursory glance of the plans and not upon a detailed examination. Any opinion expressed as to whether or not any building approval or approval under the Land (Planning and Environment) Act, 1991, is based on the limited knowledge and belief, at the time, of the Inspector. The Purchaser is advised that a Special Purpose Report is available through the Inspector to advise more fully in respect to these matters. The structures may have been damaged by pests, storm, strong wind or fire or the Vendor may have carried out alterations and/or additions to the Property since the Inspection Date. The Report may no longer reflect the true condition of the Property. The structure(s) may no longer be in accordance with the attached plans etc. IT IS STRONGLY RECOMMENDED that, if the Purchaser has any concerns in respect to the compliance of the structures, a Special Purpose Report be obtained. Alternatively, the Purchaser should rely upon his, her or their own enquiries.

**Contact the Inspector:** Please feel free to contact the Inspector who carried out this Inspection. Often it is very difficult to fully explain situations, problems, access difficulties, building faults or their importance in a manner that is readily understandable by the reader. Should you have any difficulty in understanding anything contained within this Report, then you should immediately contact the Inspector and have the matter explained to you. If you have any questions at all, or require any clarification, then contact the Inspector prior to acting on this Report.

## OTHER INSPECTIONS AND REPORTS REQUIRED

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It is strongly recommended that the following Inspections and Reports be obtained prior to any decision to purchase the Property. Obtaining these Reports will better equip the purchaser to make an informed decision. Although appliances may be listed in the Report, they have not been tested as this is outside the scope of the standard Building Inspection. Other Inspections we recommend the purchaser obtains before making their decision are:

- Electrical Inspection,
- Plumbing Inspection,
- Structural (Engineer),
- Geotechnical Inspection,
- Drainage Inspection,
- Asbestos Inspection,
- Mould Inspection,
- Gas fitting Inspection,
- Appliances Inspection,
- Air-conditioning Inspection,
- Alarm/Intercom/Data Systems,
- Hydraulics Inspection,
- Mechanical Services,
- Hazards Inspection,
- Fire/Chimney Inspection,
- Estimating Report,
- Garage Door Mechanical,
- Durability exposed surfaces

## SMOKE DETECTORS

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The occupier/purchaser should satisfy themselves as to the working condition of the smoke detectors, if installed. It is highly recommended that suitable smoke detectors be installed in all residential properties. AS 3786 advises that smoke detectors are required for all buildings where people sleep. It is recommended that an electrician be consulted to advise on those installed or install these detectors.

## CRACKING OF BUILDING ITEMS

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Regardless of the type of crack(s), a Pre-Purchase Building Inspector carrying out a Pre-Purchase Inspection within the scope of a visual Inspection is unable to determine the expected consequences of the cracks.

Obtaining Information regarding the below all fall outside the scope of this Pre-Purchase Inspection:

- (a)** The nature of the foundation material on which the building is resting,
- (b)** The design of the footings,
- (c)** The site landscape,
- (d)** The history of the cracks and,
- (e)** Carrying out an invasive Inspection.

However, the information obtained from the five items above is valuable in determining the expected consequences of the cracking and any remedial work needed. Cracks that are small in width and length on the day of the Inspection may have the potential to develop over time into structural problems for the homeowner, resulting in major expensive rectification work being carried out. If cracks have been identified in the Report above, then a Structural Engineer is required to determine the significance of the cracking prior to a decision to purchase.

## NOTICE TO THE PURCHASER (ACT ONLY)

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(a) At the Exchange, and prior to the 'Cooling-off Period', you were given an Inspection Report on the property you intend on purchasing. This Report reflects the condition of the property existing at the time of the Inspection (Inspection Date) and may not reflect the current state. The structures may have been damaged by pests, storm, strong wind or fire or the vendor may have carried out alterations and/or additions to the property since the Inspection date. The Report may no longer reflect the true condition of the property. The structure(s) may no longer be in accordance with the attached plans etc. It is, therefore, very strongly recommended that you urgently arrange for another Inspection and Report in accordance with Australian Standard AS 4349.1 to be carried out prior to exchange, or prior to the expiration of any 'Cooling Off Period' and prior to settlement.

(b) If the Report indicated the presence of termite damage, or recommends any other Inspections or treatments, you should obtain copies of these Reports and any treatment proposals, certificates of treatment carried out, including details of all repairs including copies of quotations, invoices, and any other Reports. It is strongly recommended that you arrange for an Inspection and Report in accordance with AS 4349.3 to verify that the treatment has been successful and carried out in accordance with AS 3660.2, and a further building Inspection in accordance with AS 4349.1.

(c) If you fail to procure a further Inspection and Report as recommended in (a) and (b), or fail to obtain copies of other Reports, treatment proposals, certificates of treatment carried out, details of all repairs including copies of quotations, invoices and any other Reports as recommended in (b) above, then you agree that you have decided not to have a further Inspection and Report carried out, or to obtain copies of treatment proposals, certificates of treatment carried out, details of all repairs including copies of quotations, invoices and any other Reports and have relied upon your own enquires and the Report, knowing the possible consequences, and that the condition of the property, as stated in the Report, may have changed.

(d) You agree that the person carrying out the Inspection **and** the company, partnership or sole trader that employs that person will have no liability to you for any damage or loss you may suffer as a result of your entering the contract to purchase the property, or in connection with completing the purchase of the property as a result of your failure to heed the advice given in (a) and (b) and the warning contained in (c) above, and may use such failure in defense of any claim that you may later make against any of them.

**NB.** It is a condition of your right to rely upon the Report that you transmit by fax, post, or otherwise deliver the signed "Notice to the Purchaser" (ACT only) to the company, partnership or sole trader at the address detailed on the front of the Report not less than four (4) days prior to the date of settlement. If you fail to complete, sign, or deliver the Notice then it will be deemed that you did not rely upon the report in respect to your decision as to whether or not to purchase the property. This may seriously affect any rights to future compensation to which you may be entitled.


**Please cross out the statement below that does not apply: - At the date of settlement, not more than 180 days will have elapsed since the Inspection date.**

1. I/We have read and understood the 'Limited Liability to a Purchaser within the Australian Capital Territory only' clause of the Report, and this Notice to the Purchaser. I/We have not arranged for another inspection and report in respect of the property, and it is my/our intention to **rely upon the findings contained in the report**; or

2. I/We have **arranged for another Inspection of the Property and Report** to be carried out, which I/We will use in conjunction with this Report in deciding whether to proceed with the purchase of the property; or

3. I/We have read and understood the 'Limited Liability to a Purchaser within the Australian Capital Territory only' clause of the Report, and this Notice to the Purchaser. I/We have not arranged for another Inspection and Report in respect of the property and have **relied on my/our own enquiries in respect of the condition of the property** as at the date of settlement including any changes in the condition of the property that have taken place since the Inspection date stated in the Report

# Timber Pest Report

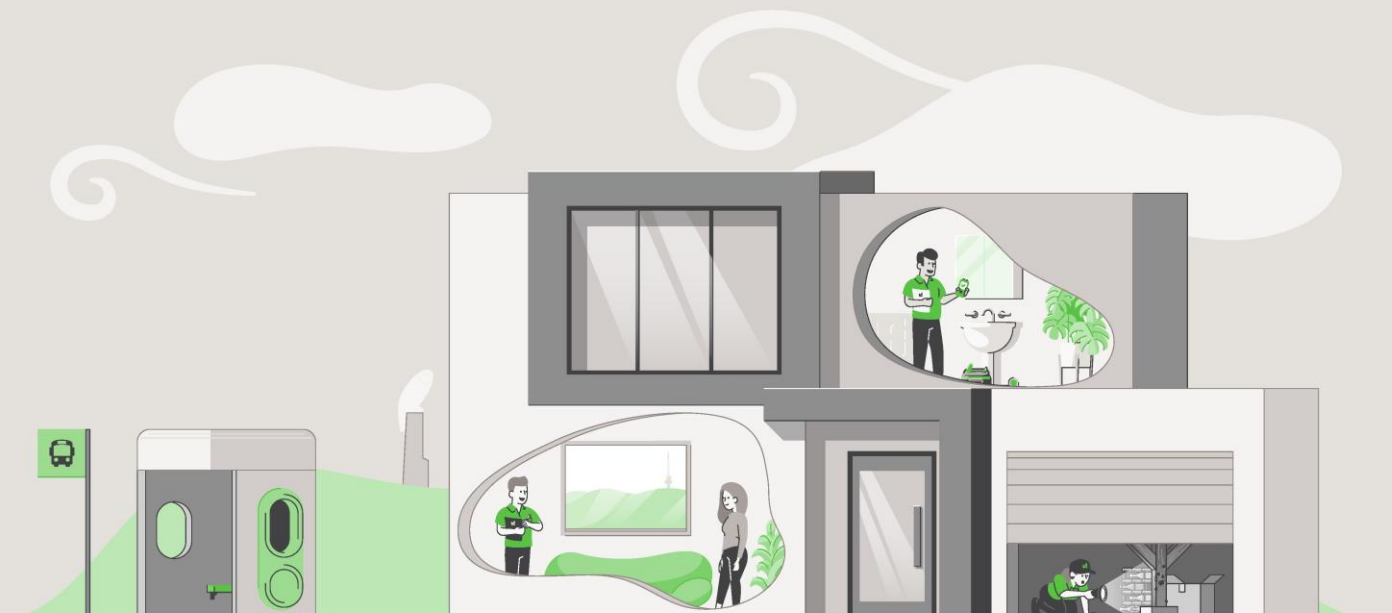

## SUMMARY SHEET

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**Property Address:** 34 Malara St, Waramanga ACT 2611  
**Client:** McSkimming  
**Inspection Date:** Thursday, February 26<sup>th</sup> 2026  
**Inspection carried out by:** Dylan Mitchell

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This summary is supplied to allow a quick and superficial overview of the Inspection results. This summary is NOT the Report and cannot be relied upon on its own. This summary must be read in conjunction with the full Report and not in isolation from the Report. If there should happen to be any discrepancy between anything in the Report, and anything in this summary, the information in the Report shall override that in the summary. The Report is subject to conditions and limitations. Your attention is particularly drawn to the clauses, disclaimer of liability to third parties, limited liability to a purchaser with the Australian Capital Territory (ACT), and to the notice to the purchaser at the back of this Report.

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### 1.0 ACCESS LIMITATIONS

**There were access limitations to the inspection/report. Please refer to section 1.0 of the report.**

### 2.0 TERMITE ACTIVITY

**No active subterranean termites (live specimens) were found.**

**No visible evidence of subterranean termite workings or damage was found.**

### 3.0 BORER ACTIVITY

**Visible evidence of borers of seasoned timbers was found. Please refer to section 3.0 of the Pest Report for further information.**

### 4.0 DECAY FUNGI

**Evidence of timber wood decay was found. Please refer to Section 4.0 of the Pest Report.**

For complete and accurate information, please refer to the attached 'Visual Timber Pest Report', which is prepared in accordance with AS 4349.3.

## CONDITIONS OF THIS INSPECTION

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### Important Information:

Any person who relies upon the contents of this Report does so acknowledging that the following clauses, which define the scope and limitations of the Inspection, form an integral part of the Report.

This is a **Visual Inspection Only**, prepared in accordance with AS 4349.3, 'Inspection of Buildings Part 3: Timber Pest Inspections'. Visual Inspection was limited to those areas and sections of the property to which reasonable access (see definition) was both available and permitted on the date of Inspection.

The Inspection **did not** include breaking apart, dismantling, removing, or moving objects including but not limited to – foliage, mouldings, roof insulation/sisalation, floor or wall coverings, sidings, ceilings, floors, furnishings, appliances, or personal possessions.

The Inspector **cannot** see inside walls, between floors, inside skillion roofing, inside the eaves, behind stored goods in cupboards, or in any other areas that are concealed or obstructed.

The Inspector **did not** dig, gouge, force or perform any other invasive procedures. An invasive Inspection will not be performed unless a separate contract is entered into.

In an occupied property, it must be understood that furnishings or household items may be concealing evidence of Timber Pests, which may only be revealed when the items are moved or removed.

In the case of strata type properties, only the interior of the unit is inspected.

### Scope of Report:

This Report only deals with the detection or non-detection of Timber Pest Attack and Conditions Conducive to Timber Pest Attack discernible at the time of inspection. The inspection was limited to the Readily Accessible Areas of the Building and Site (see note below) and was based on a visual examination of surface work (excluding furniture and stored items), and the carrying out of Tests. Note. With strata and company title properties, the inspection was limited to the interior and the immediate exterior of the particular residence inspected. Common property was not inspected.

### Limitations:

The Client acknowledges:

**(a)** This Report does not include the inspection and assessment of matters outside the scope of the requested inspection and report.

**(b)** The inspection only covered the Readily Accessible Areas of the Building and Site. The inspection did not include areas which were inaccessible, not readily accessible or obstructed at the time of inspection. Obstructions are defined as any condition or physical limitation which inhibits or prevents inspection and may include – but are not limited to – roofing, fixed ceilings, wall linings, floor coverings, fixtures, fittings, furniture, clothes, stored articles/materials, thermal insulation, sarking, pipe/duct work, builder's debris, vegetation, pavements, or earth.

**(c)** The detection of dry wood termites may be extremely difficult due to the small size of the colonies. No warranty of absence of these termites is given.

**(d)** European House Borer (*Hylotrupes bajulus*) attack is difficult to detect in the early stages of infestation as the galleries of boring larvae rarely break through the affected timber surface. No warranty of absence of these borers is given. Regular inspections including the carrying out of appropriate tests are required to help monitor susceptible timbers.

**(e)** This is not a structural damage report. Neither is this a warranty as to the absence of Timber Pest Attack.

**(f)** If the inspection was limited to any particular type(s) of timber pest (e.g., subterranean termites), then this would be the subject of a Special-Purpose Inspection Report, which is adequately specified.

**(g)** This Report does not cover or deal with environmental risk assessment or biological risks not associated with Timber Pests (e.g., toxic Mould) or occupational, health or safety issues. Such advice may be the subject of a Special-Purpose Inspection Report which is adequately specified and must be undertaken by an appropriately qualified inspector. The choice of such inspector is a matter for the Client.

**(h)** This Report has been produced for the use of the Client. The Consultant or their firm or company are not liable for any reliance placed on this report by any third party, except as provided in the section Limited Liability To a Purchaser within the Australian Capital Territory.

**Determining extent of Damage:**

This is not a structural building report, and any inexpert opinion we provide on timber damage cannot be relied upon. This Report **will not** state the full extent of any Timber Pest damage. It will state Timber Pest Damage found as either 'slight', 'moderate', 'moderate to extensive', or 'extensive', and this information is not the opinion of an expert. If any evidence of Timber Pest activity and/or damage resulting from Timber Pest activity is reported, either in the structure(s) or the grounds of the property, then you must assume that there may be concealed structural damage within the building(s).

This concealed damage may only be found when wall linings, cladding or insulation are removed to reveal previously concealed timbers. In this case, an Invasive Timber Pest Inspection (for which a separate contract is required) is strongly recommended, and you should arrange for a qualified professional such as a builder, engineer, or architect to carry out a structural Inspection to determine the full extent of the damage, and the extent of repairs that may be required. You agree that neither we, nor the individual conducting the Inspection, are responsible or liable for the repair of any damage, whether disclosed by the Report or not.

**Disclaimer of Liability:**

No liability shall be accepted on account of failure of the Report to notify any termite activity and/or damage present at, or prior to, the date of the Report, in any area(s) or section(s) of the subject property physically inaccessible for Inspection, or to which access for Inspection is denied by, or to, the licensed Inspector (including, but not limited to, any area(s) or section(s) specified by the Report).

## 1.0 ACCESS LIMITATIONS

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### 1.1 Area(s) inspected:

Only structures, fences &/or trees within 50m of the building but within the property boundaries were inspected.

### 1.2 Common area(s) not inspected:

No Inspection was made, and no Report will be submitted, of inaccessible area(s).

These include, but may not be limited to; cavity walls, concealed frame timbers, eaves, flat roofs, fully enclosed patios, inaccessible parts of the subfloors, inaccessible parts of the roof void, soil concealed by concrete floors, fireplace hearths, wall linings, landscaping, rubbish, floor coverings, furniture, pictures, appliances, stored items, insulation, and hollow blocks/posts etc.

### 1.3 Area(s) in which visual inspection was obstructed or restricted and why:

**Ceiling framing timbers were concealed by insulation. Clothing and other stored items concealed timbers in cupboards and built in robes/closets. Furniture and stored items concealed some of the skirting boards and architraves inside the house. Areas of the timber fence were concealed by vegetation. Ducting flex throughout the roof space restricting access in areas. The inspection of the garage was restricted due to stored goods being kept in the area at the time of inspection.**

**NB.** Please note that since a complete Inspection of the above area(s) was not possible, Timber Pest activity and/or damage may exist in these areas.

### 1.4 The property was furnished at the time of inspection.

Where a property is furnished at the time of Inspection, it must be understood that the furnishings and stored goods may be concealing evidence of Timber Pest activity. This evidence may be revealed when the property is vacated, and a further Inspection of the vacant property is strongly recommended if the house was furnished at the time of inspection.

### 1.5 Undetected timber pest risk assessment is considered Low/Moderate.

**NB.** Where the risk is considered “Moderate” or “Moderate-High” or “High”, a further inspection is strongly recommended of areas that were not readily accessible, and of inaccessible or obstructed areas once access has been provided or the obstruction removed. This may require the moving, lifting or removal of obstructions such as floor coverings, furniture, stored items foliage and insulation. In some instances, it may also require the removal of ceiling and wall linings, and the cutting of traps and access holes. Seek further advice from your Consultant.

## 2.0 TERMITE ACTIVITY

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**2.1 No active (live) termites were present at the time of Inspection.**

**2.2 No visible evidence of subterranean termite workings and/or damage was found.**

**2.3 A termite nest was not found.**

**2.4 No evidence of timber damage caused by Termite attack was visible at the time of the Inspection.**

NB. Where evidence of termite activity by the *Nasutitermes* or *Coptotermes* species was found in the grounds, the risk to buildings is very high. A treatment to eradicate the termites and to protect the building(s) should be carried out. Where the evidence of termite workings was found in the grounds or the building(s), then the risk of a further attack is very high.

### **2.5 Very important:**

If live termites or any evidence of termite workings or damage was reported above, within the building(s) or in the grounds and fences, then it must be assumed that there may be concealed termite activity and/or timber damage. This concealed activity or damage may only be found when alterations are carried out, such as when wall linings, cladding or insulation are removed; or if you arrange for an invasive Inspection. We claim no expertise in structural engineering or building, and we strongly recommend that you have a qualified professional such as a builder, engineer, architect, or other qualified expert determine the full extent of the damage, if any. This may require an invasive Inspection. We take no responsibility for the repair of any damage, whether disclosed by this Report or not (see 'Terms and Limitations').

Where visual evidence of termite workings and/or damage is reported above, but no live termites were present at the time of Inspection, you must realise that it is possible that termites are still active in the immediate vicinity, and that the termites may continue to cause further damage. It is not possible, without further investigation and a number of Inspections over a period of time, to ascertain whether any infestation is active or inactive. Active termites may simply have not been present at the time of Inspection due to a prior disturbance or climatic conditions, or they may have been utilizing an alternative feeding source.

Continued, regular Inspections are essential. Unless written evidence of a termite protection program in accordance with 'AS 3660' with ongoing Inspections is provided, you must arrange for a treatment in accordance with 'AS 3660' to be carried out to reduce the risk of further attack.

**2.6 Previous termite treatment: There were no signs of a termite treatment or evidence of a possible previous termite treatment, at the time of inspection.**

**NB.** If there is evidence of drill holes in concrete or brickwork, bait stations or other signs of a possible previous treatment are reported, then the treatment was probably carried out because of an active termite attack. Extensive structural damage may exist in concealed areas. You should have an invasive Inspection carried out, and have a builder determine the full extent of any damage, and the estimated cost of repairs, as the damage may only be found when wall linings etc. are removed. Normally, if a termite treatment has been carried out, then a durable notice should be located in the metre box, indicating the type of termite shield system, treated zone or combination that has been installed.

**2.7 Termite management: A durable notice (termite management notice) was not found during the inspection, indicating a barrier system has not been installed.**

This firm can give no assurances with regard to work that may have been previously performed by other firms. You should obtain copies of all paperwork and make your own enquiries as to the quality of the treatment when it was carried out, and warranty information. In most cases, you should arrange for a treatment in accordance with "Australian Standard 3660" to be carried out to reduce the risk of further attack.

### **2.8 General remarks:**

Where any current visible evidence of Timber Pest activity is found, it is strongly recommended that a more invasive Inspection be performed. Trees on and near the property up to a height of 2 metres, have been visually Inspected where possible and practicable, for evidence of Termite activity. It is very difficult to locate termite nests since they are underground, and evidence in trees is usually well concealed. Therefore, we strongly recommend that you arrange to have the medium to large eucalypt trees within a 50 metre radius of the property test drilled for evidence of termite nests.

### 3.0 BORER ACTIVITY

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**3.1 Lyctus borer workings was found in several timber bearers and joists in the subfloor region. The damage has been caused by Lyctus brunneus (powderpost beetle) and is not of structural concern. No repairs or treatment are required.**

The **Lyctid Borer** - The most common lyctid borer in Australia is **Lyctus brunneus (powder post beetle)**. Attack usually takes place during the first six to twelve months of the service life of timber. However, the powder post beetle is not considered a significant pest of timber and treatment of infestation is not usually required. As only the sapwood of certain hardwoods is destroyed, larger-dimensional timbers (such as rafters, bearers, and joists) in a building are seldom weakened significantly to cause collapse. The **Anobiid Borer** There are many different species of Anobiid borer, the most frequently encountered being *Anobium punctatum* (furniture beetle) and *Calymmaderus incisus* (Queensland pine beetle). Attack mainly occurs to softwoods especially pine timbers such as floorboards that have been in service for at least ten years. Should any structural timbers be attacked by Anobiid borers it is often difficult to determine what extent the borer damage has weakened such timbers and replacement is often the only way of ensuring safety from collapse.

In the case of Anobiid borers, once an attack is initiated it is unlikely to cease or die out of its own accord without some sort of eradication treatment. Therefore, unless proof of treatment is provided, evidence of an attack must always be considered active. Although a chemical treatment is an option, replacement of infested timbers with non-susceptible, or treated timber, is the most effective method of treatment. Before any option is considered, competent advice (e.g., from a licensed building contractor) should be sought to determine the extent of any structural damage, and as to the need or otherwise for rectification or repair work.

**Other Borers:** A further (more invasive) investigation is strongly recommended to determine whether infestation is still active and to positively identify the borer species responsible for the attack. Always seek further advice from the Consultant.

**Management Program:** Wherever practical, remove any conditions conducive to attack (e.g., *Anobium* borer thrive in badly ventilated subfloor areas). Regular inspections are recommended at intervals not exceeding 12 months. Always seek further advice from the Consultant.

## 4.0 DECAY FUNGI

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### 4.1 Evidence of damage caused by wood decay (rot) fungi was found.

- **Timber decay was found in areas of the timber fence palings, the rear pergola, the subfloor under the bathroom, the front pergola, and the timber fascia.**

**NB.** If any evidence of fungal decay or damage is reported, you should consult a building expert to determine the full extent of damage, and the estimated cost of repairs or timber.

General Description of Attack Decaying wood contains sufficient moisture to retain its original shape and may have sufficient strength to withstand normal loads. In contrast decayed wood is reduced both in moisture content and size as indicated by cracking either along or across the grain or fibres coming apart in a stringy manner. Decayed wood will have undergone considerable strength reduction.

Economic Significance Fungal decay can cause at one extreme, structural failure of the affected timber, and at the other purely superficial surface damage. The most critical determination is that of which timber is affected and decaying because decay will most likely spread (unless sources of moisture are quickly removed). Affected and decayed timber may warrant timber replacement, but the rot should not spread unless a new moisture source becomes available in that area.

Where evidence of decayed timber exists, competent advice (e.g., from a licensed or registered building contractor) should be sought to determine the extent of any structural damage, and as to the need or otherwise for rectification or repair work. It is important to correct any condition conducive to attack prior to replacing decayed wood.

Where evidence of decaying timber exists, competent advice (e.g., from a licensed or registered building contractor) should be sought to remove the condition(s) conducive to attack, and to determine the extent of any structural damage, and as to the need or otherwise for rectification or repair work.

Where the full extent of damage or the overall condition of the timber is undetermined a further inspection is strongly recommended by a competent person (e.g., from a licensed or registered building contractor). This may require monitoring of the timber over a period and include the assessment of conditions conducive to attack in different weather conditions (e.g., to determine the adequacy of existing drainage).

Management Program Remove any conditions conducive to attack (e.g., lack of ventilation or the presence of excessive moisture). Regular inspections are recommended at intervals not exceeding 12 months. Always seek further advice from the Consultant.

## 5.0 CONDITIONS THAT ARE CONDUCTIVE TO TIMBER PESTS

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### 5.1 Water leaks: At the time of the inspection the shower in the bathroom was leaking.

Water leaks, especially in or into the subfloor, or against the external walls; increase the likelihood of termite attack. Leaking showers or leaks from other 'wet areas' also increase the likelihood of concealed termite attack. Hot water overflows should be plumbed away from the building.

**NB.** We claim no expertise in building, and if any leaks were reported, you should consult a plumber or other building expert to determine the full extent of damage, and the estimated cost of repairs.

### 5.2 Moisture/drainage: At the time of the inspection, the subfloor soil was generally dry.

Lack of Adequate Subfloor Ventilation Inadequate ventilation provides a condition suitable for timber pest infestation. For example, subterranean termites thrive in damp humid conditions typical of those provided in a poorly ventilated subfloor space. Where evidence of a lack of adequate ventilation has been identified in the report, the Client should seek competent advice (e.g., from a licensed or registered building contractor) regarding upgrading ventilation. The Presence of Excessive Moisture Ground levels around the building should be maintained in such a way to minimise water entering under the building. Also, the ground surface in subfloor areas should be kept graded to ensure that moisture does not pond or accumulate in any area. Where necessary, sub-surface drains should be installed and maintained to assist with drainage around and under the building. Likewise, the presence of excessive moisture can often be directly related to ventilation limitations and the resultant high humidity. Also, plumbing oversights and defects such as a leaking drain or tap will provide a microclimate conducive to timber pest attack. Where necessary, the Client should seek competent advice (e.g., from a licensed or registered plumbing contractor) to determine the adequacy of existing drainage and remove any conditions conducive to the presence of excessive moisture. The building may need to be monitored over a period of time to detect or confirm a damp problem. The presence of dampness (including moisture) is not always consistent as the prevailing and recent weather conditions at the time an inspection is carried out may affect the detection of damp problems. Importantly, precipitation at or near the time of inspection does not necessarily guarantee that a damp problem will automatically be evident due to such circumstances as prevailing wind conditions or intensity of rainfall. The absence of any dampness at the time of inspection does not necessarily mean the building will not experience some damp problems in other weather conditions. Likewise, whether services have been used for some time prior to an inspection being carried out will affect the detection of dampness.

### 5.3 Ventilation: Generally adequate.

Lack of Adequate Subfloor Ventilation Inadequate ventilation provides a condition suitable for timber pest infestation. For example, subterranean termites thrive in damp humid conditions typical of those provided in a poorly ventilated subfloor space. Where evidence of a lack of adequate ventilation has been identified in the report, the Client should seek competent advice (e.g., from a licensed or registered building contractor) in regard to upgrading ventilation.

### 5.4 Hot water services and air conditioning units: There is no need for this work to be carried out.

Hot water services and air conditioning units which release water alongside or near to building walls should be piped to a drain (if not possible then several metres away from the building), as the resulting wet area is highly conducive to termites.

### 5.5 Slab edge exposure: The slab edge inspection zone does not apply to this property.

Where external concrete slab edges are not exposed, there is a high risk of concealed termite entry.

In some buildings built since July 1995, the edge of the slab forms part of the termite shield system. In these buildings an Inspection zone of at least 75mm should be maintained to permit detection of termite entry. The edge should not be concealed by render, tiles, cladding, flashings, adjoining structures, paving, soil, turf, or landscaping etc. Where this is the case, you should arrange to have the slab edge exposed for Inspection.

Concealed termite entry may already be taking place but could not be detected at the time of the Inspection. This may have resulted in concealed timber damage.

**NB.** A very high proportion of termite attacks are over the slab edge. Covering the slab edge makes concealed entry easy. This is particularly true of infill type slab construction. Termite activity and/or damage may be present in concealed timbers of the building. We strongly recommend frequent regular inspections in accordance with AS 3660.2.

**5.6 Weep holes in external walls: Weep holes are not applicable to this property.**

It is very important that soil, lawn, concrete paths, or pavers do not cover the weep holes. Sometimes, they have been covered during the rendering of the brick work. They should be clean and free flowing and covering the weep holes in part or in whole may allow undetected termite entry.

**5.7 Termite shields: Inadequate, as ant capping is not continuous. This is typical for a home of this age.**

Termite Shields (Ant Caps) should be in good order and condition, so termite workings are exposed and visible. This helps prevent termites from gaining undetected entry. Joins in the shielding should have been soldered during the installation. If it is observed that the joins in the shielding have not been soldered, then the shielding must be reported as inadequate. It may be possible for a builder to repair the shielding. If not, a chemical treated zone may need to be installed to deter termites from gaining concealed access to the building. Missing, damaged or poor shields increase the risk of termite infestation. If considered inadequate, a builder or other building expert should be consulted.

Other physical shield systems are not visible to inspection and no comment is made on such systems.

**5.8 Bridging or breaching of termite barriers and inspection zones: No bridging or breaching was found.**

“Bridging” is the spanning of a termite barrier or inspection zone so that subterranean termites are provided with passage over or around that barrier. “Breaching” is the making of a hole or gap in a termite barrier so that termites are provided with a passage through that barrier.

**5.9 Other area(s) and/or situations that appear conducive to (may attract) subterranean termite infestation: Medium to large trees and stumps within a 50 metre radius of the property, due to the nesting conditions. Several timber off cuts on the ground in the subfloor, due to the ideal food source. The landscaped timbers, due to the food source.**

## 6.0 OVERALL ASSESSMENT OF THE PROPERTY

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**6.1** Where evidence of live termites, termite damage or termite workings (mudding) was found in the building(s) then the risk of a further attack is extremely high.

Where evidence of live termites, termite damage or termite workings was found in the grounds but not in the building(s) then the risk to buildings must be reported as high to extremely high.

**6.2** At the time of the Inspection, the degree of risk of subterranean termite infestation to the overall property was considered to be **Moderate to High**.

**6.3 Subterranean Termite Treatment Recommendation:** A management program in accordance with AS 3660-2000 to protect against subterranean termites is considered **not essential, but 6 to 12 monthly inspections are essential**.

**6.4 Future Inspections:** AS 3660.0-2000 recommends “regular competent Inspections should be carried out at least on an annual basis, but more frequent Inspections are strongly recommended”.

It goes on to inform that “regular Inspections will not prevent termite attack but may help in the detection of termite activity. Early detection will allow remedial treatment to be commenced sooner, and damage to be minimized”.

Due to the degree of risk of subterranean termite infestation noted above and all other findings of this Report; we strongly recommend that a full Inspection and written Report in accordance with AS 4349.3 or AS 3660.2-2000 is conducted at this property every 6 months, but no more than 12 months.

## DEFINITIONS

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**Timber Pest Attack:** Means Timber Pest Activity and/or Timber Pest Damage.

**Timber Pest Activity:** Means telltale signs associated with 'active' (live) and/or 'inactive' (absence of live) Timber Pests at the time of inspection.

**Timber Pest Damage:** Means noticeable impairments to the integrity of timber and other susceptible materials resulting from attack by Timber Pests.

**Major Safety Hazard:** Means any item that may constitute an immediate or imminent risk to life, health or property resulting directly from Timber Pest Attack. Occupational, health and safety or any other consequence of these hazards has not been assessed.

**Conditions Conducive to Timber Pest Attack:** Means noticeable building deficiencies or environmental factors that may contribute to the presence of Timber Pests.

**Readily Accessible Areas:** Means areas which can be easily and safely inspected without injury to person or property, are up to 3.6 metres above ground or floor levels, in roof spaces where the minimum area of accessibility is not less than 600 mm high by 600 mm wide and subfloor spaces where the minimum area of accessibility is not less than 400 mm high by 600 mm wide, providing the spaces or areas permit entry. The term 'readily accessible' also includes accessible subfloor areas on a sloping site where the minimum clearance is not less than 150 mm high, provided that the area is not more than 2 metres from a point with conforming clearance (i.e., 400 mm high by 600 mm wide); and areas at the eaves of accessible roof spaces that are within the consultant's unobstructed line of sight and within arm's length from a point with conforming clearance (i.e. 600 mm high by 600 mm wide).

**Client:** Means the person or persons for whom the Timber Pest Detection Report was carried out or their Principal (i.e., the person or persons for whom the report was being obtained).

**Timber Pest Detection Consultant:** Means a person who meets the minimum skills requirement set out in the current Australian Standard AS 4349.3 Inspections of Buildings. Part 3: Timber Pest Inspection Reports or state/territory legislation requirements beyond this Standard, where applicable.

**Building and Site:** Means the main building (or main buildings in the case of a building complex) and all timber structures (such as outbuildings, landscaping, retaining walls, fences, bridges, trees, and stumps with a diameter greater than 100 mm and timber embedded in soil) and the land within the property boundaries up to a distance of 50 metres from the main building(s).

**Timber Pests:** Means one or more of the following woods destroying agents which attack timber in service and affect its structural properties:

**Chemical Delignification:** The breakdown of timber through chemical action.

**Fungal Decay:** The microbiological degradation of timber caused by soft rot fungi and decay fungi, but does not include Mould, which is a type of fungus that does not structurally damage wood.

**Wood Borers:** Wood destroying insects belonging to the order 'Coleoptera' which commonly attack seasoned timber.

**Termites:** Wood destroying insects belonging to the order 'Isoptera' which commonly attack seasoned timber.

**Tests:** Means additional attention to the visual examination was given to those accessible areas which the consultant's experience has shown to be particularly susceptible to attack by Timber Pests. Instrument testing of those areas and other visible accessible timbers/materials/areas showing evidence of attack was performed.

**Instrument Testing:** Means where appropriate the carrying out of Tests using the following techniques and instruments:

- (a) Electronic moisture detecting meter - an instrument used for assessing the moisture content of building elements.
- (b) Stethoscope - an instrument used to hear sounds made by termites within building elements.
- (c) Probing - a technique where timber and other materials/areas are penetrated with a sharp instrument (e.g., bradawl or pocket knife), but does not include probing of decorative timbers or finishes, or the drilling of timber and trees; and
- (d) Sounding - a technique where timber is tapped with a solid object.

## IMPORTANT MAINTENANCE ADVICE REGARDING INTEGRATED PEST MANAGEMENT FOR PROTECTING AGAINST TIMBER PESTS

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You should read and understand the following important information. It will help explain what is involved in a Timber Pest Inspection, the difficulties faced by a Timber Pest Inspector, and why it is not possible to guarantee that a property is free of Timber Pests. It also details important information about what you can do to help protect your property from Timber Pests. This information forms an integral part of the Report. Any structure can be attacked by Timber Pests. Periodic maintenance should include measures to minimise possibilities of infestation in and around a property. Factors which may lead to infestation from Timber Pests include situations where the edge of the concrete slab is covered by soil or garden debris, filled areas, areas with less than 400mm clearance, foam insulation at foundations, earth/wood contact, damp areas, leaking pipes, etc.; form-work timbers, scrap timber, tree stumps, mulch, tree branches touching the structure, wood rot, etc. Gardens, pathways, or turf abutting or concealing the edge of a concrete slab will allow for concealed entry by timber pests any timber in contact with soil such as form-work, scrap timbers or stumps must be removed from under and around the buildings and any leaks repaired. You should endeavor to ensure such conditions DO NOT occur around your property. We further advise that you engage a professional pest control firm to provide a termite management program in accord with AS 3660 to minimise the risk of termite attack. There is no way of preventing termite attack. Even AS 3660 advises that "the provision of a complete termite barrier will impede and discourage termite entry into a building. It cannot prevent termite attack. Termites can still bridge or breach barriers, but they can be detected more readily during routine inspections."

### **Reasonable access:**

Unless specified in writing, the inspection only covered the Readily Accessible Areas of the Building and Site.

The inspection did not include areas which were inaccessible, not readily accessible or obstructed at the time of inspection. Areas which are not normally accessible were not inspected and include - but not limited to – inside walls, the interior of a flat roof or beneath a suspended floor filled with earth.

Building Interior, the Consultant did not move or remove any ceilings, wall coverings, flooring, floor coverings (including carpeting), furnishing, equipment, appliances, pictures, or other household goods. In an occupied property, furnishings or household items may be concealing evidence of timber pest attack which may only be revealed when the items are moved or removed.

Building Exterior, Roof Exterior and Site, the Consultant did not move or remove any obstructions such as wall cladding, awnings, trellis, earth, plants, bushes, foliage, stored materials, debris, or rubbish. Due to the 'secretive' nature of timber pests, it is possible that hidden damage may exist in concealed areas, e.g., wall framing. Damage may only be found when the obstruction is removed. In the case of buildings constructed on concrete slabs, if the edge of the slab or any weep hole or vent at the base of external walls is concealed by pavements, gardens, lawns, or landscaping then it is possible for termites to gain undetected entry into the building. The building of gardens or planting of shrubs close to the perimeter of the building can promote and conceal termite entry points. The storage of cellulose materials such as building materials and firewood near the ground or building may encourage termite activity.

Roof Space Obstructions such as roofing, stored articles, thermal insulation, sarking, and pipe/duct work may be concealing evidence of timber pest attack which may only be revealed when the obstructions are moved or removed. Also, bodily access should be provided to the interior of all accessible roof spaces. In accordance with Australian Standard ASS 4349 the minimum requirement is a 400mm by 500 mm access manhole.

Subfloor Space Subfloor areas should be kept free from all vegetation (including tree stumps) and other cellulose material which may encourage timber pest activity. Also, storage of materials in subfloor areas is not recommended as it reduces ventilation and makes inspection difficult. Obstructions may be concealing evidence of timber pest attack which may only be revealed when the obstructions are moved or removed. Bodily access should be provided to all accessible subfloor areas with the minimum requirement being a 500 mm x 400 mm access manhole. In the case of suspended floors, if the clearance between the ground and structural components is less than 400 mm, then the ground should be excavated to provide the required clearance, subject to maintaining adequate drainage and support to footings. If the subfloor has been sprayed for subterranean termites or if the area is susceptible to mould growth, appropriate health precautions must be followed before entering the area. Also, special care should be taken not to disturb the treated soil. Always seek further advice from the Consultant.

A further inspection is strongly recommended of those areas that were not readily accessible and of inaccessible or obstructed areas once access has been provided or the obstruction removed. This will involve a separate visit to the site, permission from the owner of the property and additional cost.

Unless stated otherwise, any recommendation or advice given in this Report should be implemented as a matter of urgency.

**A more invasive physical inspection is available and recommended:**

As detailed above, there are many limitations to this visual inspection only. With the permission of the owner of the premises we WILL perform a more invasive physical inspection that involves moving or lifting insulation, stored items, furniture, or foliage during the inspection. We WILL physically touch, tap, test and when necessary, force/gouge suspected accessible timbers. We WILL gain access to areas, where physically possible and considered practical and necessary, by way of cutting traps and access holes.

This style of Report is available by ordering with several days' notice. Inspection time for this style of Report will be greater than for a VISUAL INSPECTION.

It involves disruption in the case of an occupied property, and some permanent marking is likely. You must arrange for the written permission of the owner who must acknowledge all the above information and confirm that our firm will not be held liable for any damage caused to the property.

A price is available on request.

**Concrete slab homes:**

Homes constructed on concrete slabs pose special problems with respect to termite attack. If the edge of the slab is concealed by concrete paths, patios, pavers, garden beds, lawns, foliage, etc. then it is possible for termites to affect concealed entry into the property, and they can then cause extensive damage to concealed framing timbers. Even the most experienced Inspector may be unable to detect their presence due to concealment by wall linings. Only when the termites attack timbers in the roof void, which may in turn be concealed by insulation, can their presence be detected. Where termite damage is in the roof, it should be expected that concealed framing timbers will be extensively damaged. With a concrete slab home, it is imperative that you expose the edge of the slab and ensure that foliage and garden beds do not cover the slab edge. Weep holes must be kept free of obstructions.

It is strongly recommended that you have a Termite Inspection in accordance with AS 3660.2 carried out every 6 to 12 months.

**Subterranean termites:**

No property is safe from termites. General Description of Attack Timber hollowed beneath; some cracking at the surface of timber; earthen channels present; or pale faecal spots present.

**Important note:**

As a delay may exist between the time of an attack and the appearance of telltale signs associated with the attack, it is possible that termite activity and damage exists though not discernible at the time of inspection.

Treatment After discovery of an active infestation, it is imperative that the species of termite is accurately identified before costly (and sometimes unnecessary or inappropriate) methods of treatment are initiated. Only economically important species which are known to attack timber structures should be treated.

In the case of economically important species, it is important that the termite workings are not further disturbed until the proposed method of control has been determined by a licensed pest control operator. Premature attempts to repair or replace infested timber may cause the termites to withdraw from the area temporarily, thereby hindering effective treatment. Any repair or replacement of infested timber should be carried out after the appropriate treatment has been completed.

Where evidence of active termites is detected within a building or within 50 metres of any building, it must always be assumed that the termites may also be active in areas of the property not inspected. Accordingly, where the termites are known to be of economic significance, a further (more invasive) inspection is strongly recommended of areas which were inaccessible, not readily accessible or obstructed at the time of inspection.

Termite Workings and Damage Where evidence of damage to building timbers exists, competent advice (e.g. from a licensed or registered building contractor) should be obtained to determine the extent of any structural damage and as to the need or otherwise for rectification or repair work.

Where evidence of inactive termites is located within the building, it is possible that termites are still active in areas of the property not inspected and they may continue to cause damage. A furthermore invasive inspection is strongly recommended of areas which were inaccessible, not readily accessible or obstructed at the time of inspection.

Where evidence of an inactive termite infestation exists, it is not possible, without benefit of further investigation and inspections over a period, to ascertain whether any infestation is active or inactive. Continued, regular, inspections are essential.

Where evidence of termite attack exists to any trees or tree stumps a more conclusive search should be undertaken. This may require the tree or stump to be drilled to determine the existence of a termite nest. In addition, the soundness and stability of any standing trees identified as being affected by termite attack should be confirmed. Always seek further advice from the Consultant.

**Previous Treatments** Where evidence of a possible termite treatment was located, the Client should obtain and keep on file all relevant documents pertaining to the extent of the treatment, any service warranties and advice in regard to the building owner's obligation to maintain the treatment and/or barrier. If evidence of a previous treatment of termite infestation is noted, and appropriate documentation is not available, the Client must assume that the termite infestation may still be active in areas of the property not inspected. Accordingly, a re-treatment may be required. Always seek further advice from the Consultant.

**Frequency of Future Inspections** Australian Standard AS 3660 recognises that regular inspections will not prevent termite attack but may help in the detection of termite activity. Early detection will allow remedial treatment to be commenced sooner and damage to be minimised.

Inspections at intervals not exceeding twelve (12) months are recommended. Where the termite risk is high or the building type susceptible to termite attack, more frequent inspections (3-6 months) should be undertaken.

**Risk management options:**

To help protect against financial loss, it is essential that the building owner immediately control or rectify any evidence of destructive timber pest activity or damage identified in this inspection report. The Client should further investigate any high-risk area where access was not gained. It is strongly advised that appropriate steps be taken to remove, rectify or monitor any evidence of conditions conducive to timber pest attack.

To help minimise the risk of any future loss, the Client should consider whether the following options to further protect their investment against timber pest infestation are appropriate for their circumstances:

Undertake thorough regular inspections at intervals not exceeding twelve months or more frequent inspections where the risk of timber pest attack is high, or the building type is susceptible to attack. To further reduce the risk of subterranean termite attacks, implement a management program in accordance with Australian Standard AS 3660. This may include the installation of a monitoring and/or baiting system, or chemical and/or physical barrier. However, AS 3660 stresses that subterranean termites can bridge, or breach barrier systems and inspection zones and that thorough regular inspection of the building are necessary.

**CONTACT THE INSPECTOR**

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Please feel free to contact the Inspector who carried out this inspection. Often it is very difficult to fully explain situations, problems, access difficulties or timber pest activity and/or damage in a manner that is readily understandable by the reader. Should you have any difficulty in understanding anything contained within this Report, then you should immediately contact the Inspector and have the matter explained to you.

If you have any questions at all or require any clarification, then contact the Inspector prior to acting on this Report.

## NOTICE TO THE PURCHASER

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**(a)** Prior to or on Exchange, and prior to the commencement of the 'Cooling-off Period', you were given an Inspection Report on the Property you intend on purchasing ("the Report"). The Purchaser is advised that this Report reflects the condition of the property existing at the time of the Inspection (Inspection Date) and may not reflect the current state. Timber Pests, particularly Termites, may have gained entry to the property since the Inspection Date. Termites can, in a relatively short period, cause significant damage to both structural and non-structural timbers within and around the buildings of the Property.

Termites (white ants) may be difficult to detect and much of the damage caused may not be readily visible. If damage exists, then it may cost thousands of dollars to repair.

It is, therefore, very strongly recommended that you urgently arrange for another Inspection and Report in accordance with AS4349.3 to be carried out prior to exchange, or prior to the expiration of any 'Cooling off Period', and prior to settlement.

**(b)** If the Report indicated the presence of Termites, termite damage or recommends any treatments or other Inspections and Reports, you should obtain copies of the treatment proposal, any certificates of treatments carried out, details of all repairs including copies of quotations, invoices, and any other Reports.

It is strongly recommended that you arrange for an Inspection and Report in accordance with AS 4349.3 to verify that the treatment has been successful and carried out in accordance with AS 3660.2 and a further building Inspection in accordance with AS 4349.1.

**(c)** If you fail to procure a further Inspection and report as recommended in (a) and (b), or fail to obtain copies of the treatment proposal, certificates of treatment carried out, details of all repairs including copies of quotations, invoices and any other reports as recommended in (b) above, then it will be deemed that you have decided not to have a further Inspection and report carried out, or to obtain copies of certificates of treatments carried out, details of all repairs including copies of quotations, invoices and any other reports.

It will be deemed that you have relied upon your own enquiries and the report, knowing the possible consequences and that the condition of the property, as stated in the report, may have changed.

**(d)** The person carrying out the Inspection and the company, partnership or sole trader that employs that person will have no liability to you for any damage or loss you may suffer as a result of your entering the contract to purchase the property or in connection with completing the purchase of the property as a result of your failure to heed the advice given in (a) and (b) and the warning contained in (c) above, and may use such failure in defense of any claim that you may later make against any of them.

# Compliance Report



## COMPLIANCE REPORT

This is a Compliance Report regarding any unapproved structures or alterations. ACT Property Inspections have accessed the attached Building File from ACT Planning and Land Authority (ACTPLA) and hold no responsibility for any inaccuracies in the Building File supplied by ACTPLA. The Compliance report is based solely upon the information available from the Building File which does not contain information regarding Plumbing or Electrical work that has taken place since the original construction. Information regarding the Plumbing and Electrical is available upon application from ACTPLA. Since we are not Plumbers or Electricians, we are unable to comment on those works. If structures have been noted as requiring approval, a Certifier should be engaged to assess if the structure will comply with the relevant ACT legislation. Owners must be aware that unapproved structures may not comply and may require significant repair, design change or possible removal.

**Property Address:** 34 Malara St, Waramanga ACT 2611  
**Block & Section:** Block 4 Section 8 WARAMANGA  
**Inspection Date:** Thursday, February 26<sup>th</sup> 2026

## APPROVAL STATUS

Description	Plan number	Certificate of occupancy date	Approval status
Brick Veneer Residence	19770	17/04/1970	Approved.
Metal Garage	19770/A	10/09/1976	Approved.
Pergola	19770/B	27/10/1988	Approved.
Additions & Alterations	104171/A	15/12/2011	Approved.
Secondary Residence	B20134966/A	-	This work did not proceed.
Replacement of bathroom floor framing	-	-	This work is unapproved as structural changes have occurred. Building approval is required.
Installation of roof covering to rear and front pergolas	-	-	This work is unapproved as the roof areas exceed 25m <sup>2</sup> . Building approval is required.
Rear retaining walls	-	-	This structure has been built inside a service easement. Should access be required to the easement by the service provider, this structure may need to be removed at the owner's expense.
Window alterations to bedroom 2 and 3 (height size reduced)	-	-	This work is exempt from approval. No action is required.


## ACTPLA COMMENTS

- No Certificate of Occupancy for B20134966/A – building approval only

## SURVEY REPORT

Survey Report completed by	Date Survey report was completed	Comments
Sowden & Wells	Friday, 5 December 1969	There are no apparent encroachments upon this land or by this property on adjoining lands or street.

# Conveyancing File

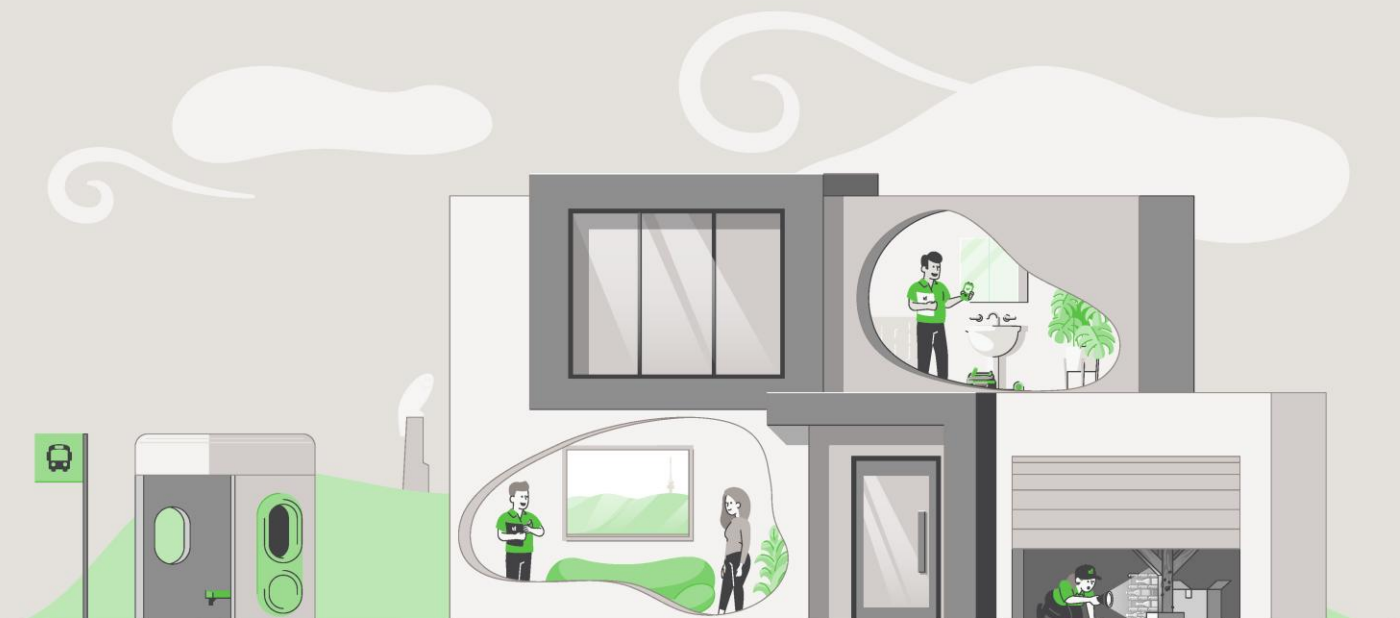

**CONVEYANCING BUILDING FILE INDEX**

SUBURB: **WARAMANGA** SECTION: **8** BLOCK: **4** UNIT: **N/A** EX GOV: **NO**

COU ISSUED Y/N	PLAN NUMBER	FOLIO NO.	DESCRIPTION OF WORK	AMEND	DETAILS	PERMIT NUMBER	COU PLAN NO. & DATE
Y	19770	-	B/V RESIDENCE				
		-				19770	
		-					19770 17/04/1970
Y	19770/A	-	METAL GARAGE				
		-				19770/A	
		-					19770/A 10/09/1976
Y	19770/B	-	PERGOLA				
		-				19770/B	
		-					19770/B 27/10/1988
Y	104171/A	-	ADDITIONS & ALTERATIONS			104171/A	
		-					104171/A 15/12/2011
N	B20134966/A	-	SECONDARY RESIDENCE			B20134966/A	
		-					

For any incomplete approvals please email [acbuildingconveyance@act.gov.au](mailto:acbuildingconveyance@act.gov.au) for further information on how to complete.

Drainage Plan Number: 15230

Survey: Y (01)

Comments: NO COU FOR B20134966/A – BUILDING APPROVAL ONLY

## CONVEYANCING PART 2

No information is provided in respect of electrical, drainage or sewer matters and or to the location of overhead power lines or underground cables in relation to the building.

	<u>Yes</u>	<u>No</u>
1. (a) Is this a government or ex government house?	<input type="checkbox"/>	<input checked="" type="checkbox"/>
(b) If yes, is there a building file with approvals on it?	<input type="checkbox"/>	<input type="checkbox"/>
2. Is there any record of incomplete building work on the building file? If yes - file copies attached	<input checked="" type="checkbox"/>	<input type="checkbox"/>
3. Are there any records on the building file of current (within 5 years) housing Indemnity insurance policies for building work? If yes - file copies attached	<input type="checkbox"/>	<input checked="" type="checkbox"/>
4. Are there any records on the building file showing building applications still being processed? (Current within 3 years) If yes - file copies attached	<input type="checkbox"/>	<input checked="" type="checkbox"/>
5. Are there any records on the building file in relation to loose-fill asbestos insulation?	<input type="checkbox"/>	<input checked="" type="checkbox"/>

**If available, copies of the following documents are provided:**

• Certificate/s of Occupancy and Use	<input checked="" type="checkbox"/>	<input type="checkbox"/>
• Survey Certificates	<input checked="" type="checkbox"/>	<input type="checkbox"/>
• Unit Plan/Unit Entitlements (if property is unit titled)	<input type="checkbox"/>	<input checked="" type="checkbox"/>
• Approved Building Plans	<input checked="" type="checkbox"/>	<input type="checkbox"/>
• Ex- government Building Plans*	<input type="checkbox"/>	<input checked="" type="checkbox"/>

**If requested:**

• Drainage Plan(s)	<input checked="" type="checkbox"/>	<input type="checkbox"/>
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### ASBESTOS

The ACT Government is not able to guarantee the accuracy of the information in this report.

You should make your own enquiries and obtain reports (from a licensed Asbestos Assessor) in relation to the presence of loose fill asbestos insulation (and other forms of asbestos) on the premises. For more information go to the Asbestos Awareness Website –

[www.asbestos.act.gov.au](http://www.asbestos.act.gov.au)

**Please note:** Development Approval plans will not be included in this report (We do not receive Development Approval Plans unless they are part of a Building Approval in which case they become Building Approval Plans), if development approval was granted you can request copies of the Development Approval plans from [ACEPDcustomerservices@act.gov.au](mailto:ACEPDcustomerservices@act.gov.au).

**Please Note:** Building approvals that have been generated via eDevelopment will be issued with a project number prefixed by the letter B. Initial building approval documentation will be identified with project number B20XXXX only but will be referenced as B20XXXX/A on the Certificate of Occupancy and Use. Any amendments to the original approval will be issued with the project number and an alphanumeric digit. The first amendment will be identified as B20XXXX/B, the second amendment B20XXXX/C etc. Not all eDevelopment plans will be stamped with the plan number.

\*Ex Government plans: Plans are typical and not specific to each residence. There may be slight changes to the layout or window locations that were not required to be approved.

Search officer comments (if any?)

Search officer initials: Tony

Cost of application: \$ 144.79

Date completed:

23/02/2026

19770 AC 17/12/69

10

**POWDERN & WELLS**  
REGISTERED SURVEYORS

34 BOUGAINVILLE STREET  
MANUKA, A.C.T. 2603



File No. ...  
DEPT. OF INTERIOR  
BUILDING BRANCH

TELEPHONE 9 1468  
PRIVATE 49 7741  
9 0538

P.O. Box 277  
MANUKA, A.C.T. 2603

RECEIVED  
19 DEC 1969

5th December, 1969

The Manager,  
Orlit Pty. Ltd.,  
P.O. Box 175,  
KINGSTON, A.C.T.

Dear Sir,

I have surveyed Block 4, Section 8, Division of WARAMANGA in the Canberra City District, Australian Capital Territory as delineated on Deposited Plan No. 2330, containing an area of  $30\frac{3}{4}$  perches more or less and having a frontage of 70.87 feet to Malara Street, such being shown by red edging on the sketch plan endorsed hereon.

Upon this land stands a residence in the course of erection to be known as No.34 Malara Street. The sketch shows the position of the residence relative to the boundaries.

The residence complies with the provisions of Clause 47 of the Canberra Building Regulations.


At present the land is unfenced.

There are no encroachments by or upon the subject land.

Yours faithfully,

REGISTERED SURVEYOR

8

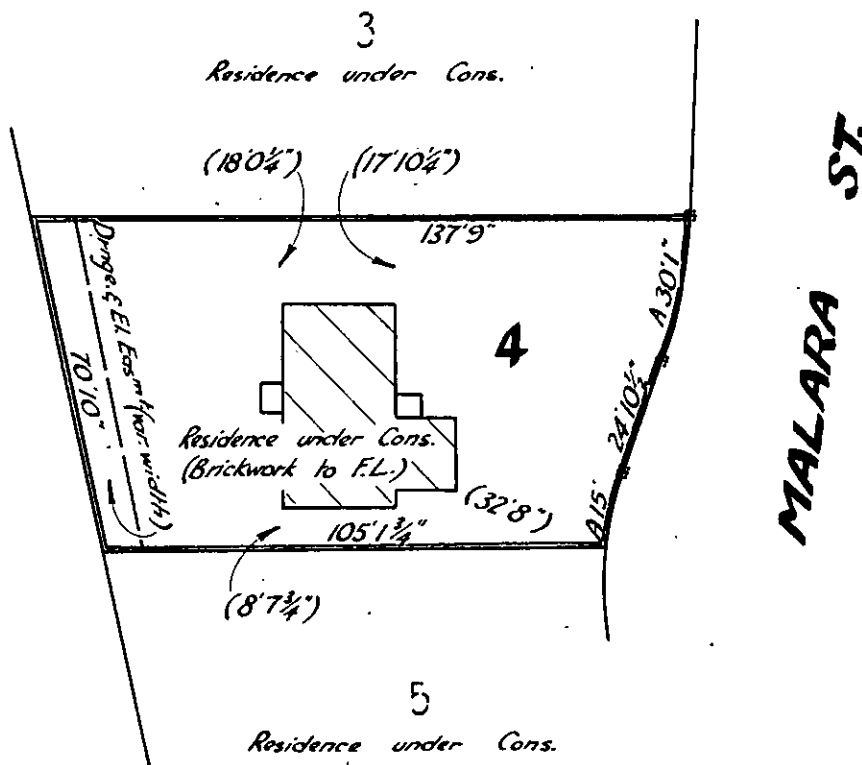

Regulation 69A

Australian Capital Territory

Building Ordinance 1964-69

Canberra Building Regulations

CERTIFICATE AS TO FITNESS FOR OCCUPANCY AND USE

I certify that a BIVENER RESIDENCE  
on Block 4 of section 8 at WARRAMANGA  
is fit for occupation and use.

Plan No. 19770

Permit Holder ORLIT P/L

Lessee ORLIT P/L

[Signature]  
Deputy Proper Authority

17 APR 1970  
Date

10816




5/12

**LEGEND:**

- EX. STORMWATER LINES
- EX. WATER SUPPLY
- EX. ELECTRICAL SERVICE

**NOTE:**  
 HYDRAULIC SERVICES LOCATED FROM DESIGN DRAWINGS BLOCK DIMENSIONS & EASEMENTS TAKEN FROM DEPT INT. SALE PLAN.

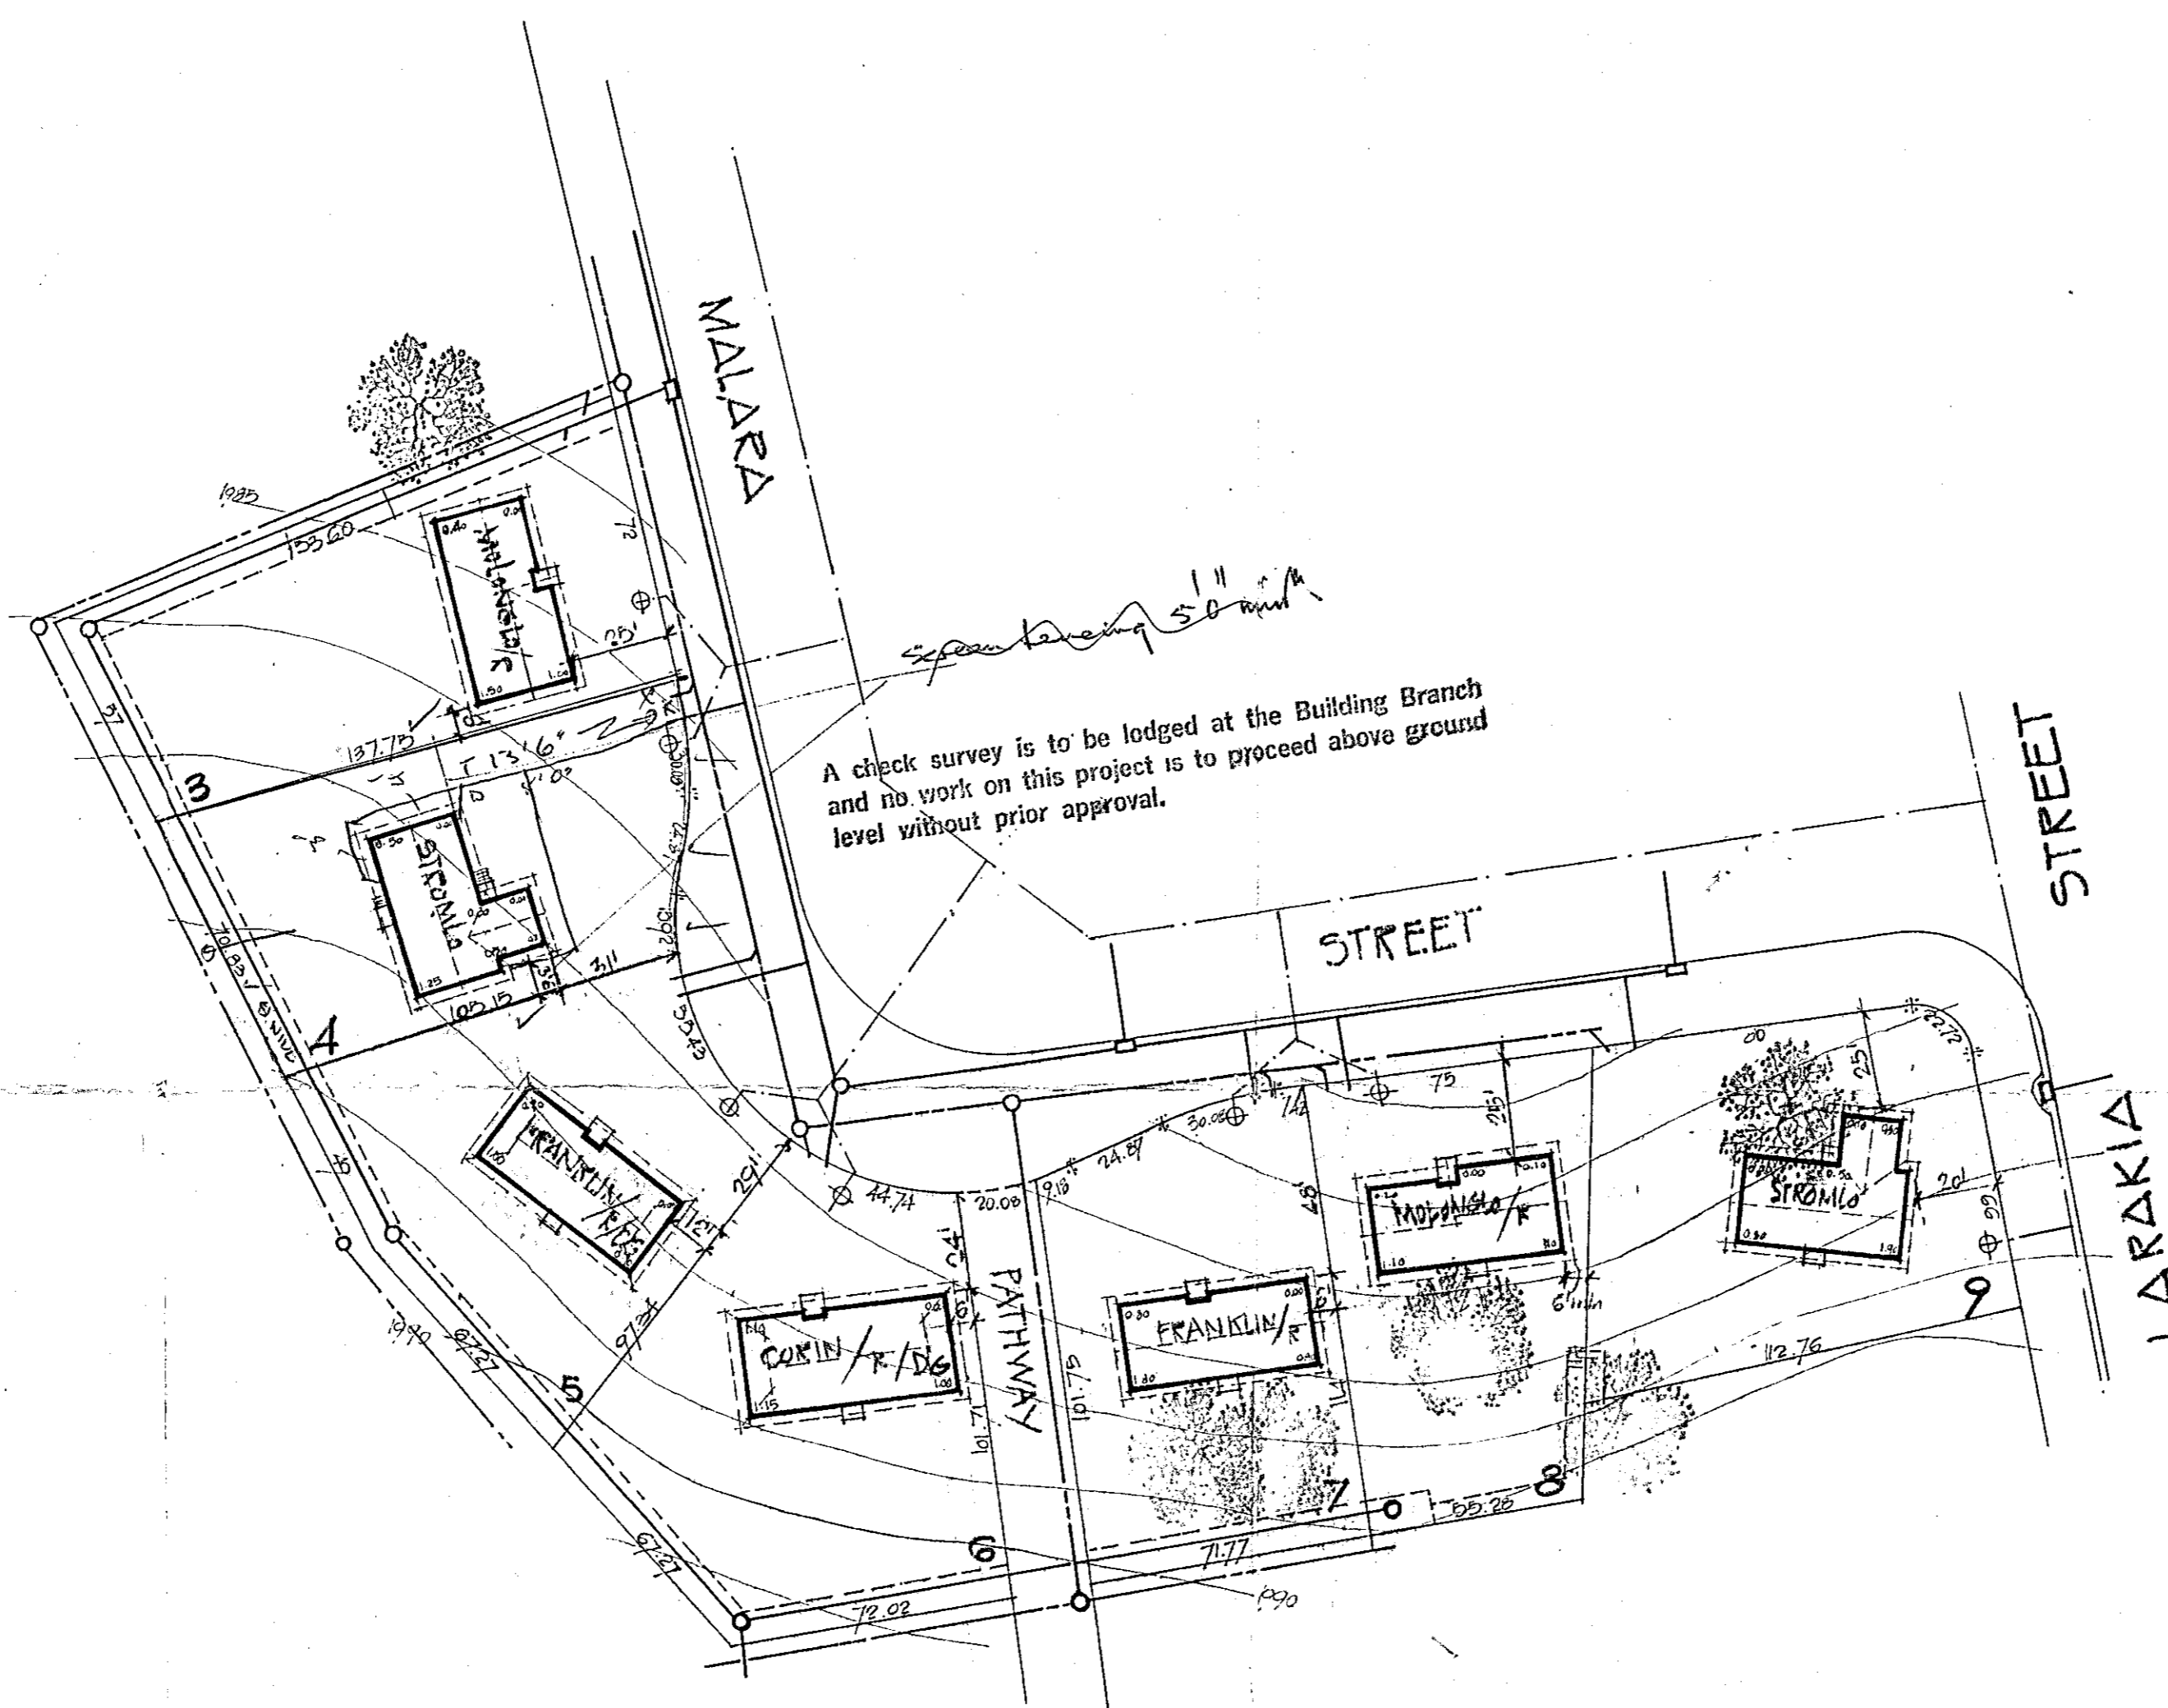

**SECTION 8**

PLANS AND SPECIFICATIONS EXAMINED AND RECOMMENDED FOR APPROVAL  
 EXAMINED BY *[Signature]* 15/10/69  
 REMINDER FOR WATER SUPPLY AND SEWERAGE  
*[Signature]* 21/10/69  
 CHIEF ELECTRICAL ENGINEER


STRUCTURAL ENGINEER *[Signature]* 1/10  
 ARCHITECT AND VALUER *[Signature]* 5/11/69  
 SERVICE ELECTRICAL OFFICER *[Signature]* 27 OCT 1969  
 APPROVED *[Signature]* 5/11/69  
 PROPER AUTHORITY  
 DEPT. OF THE INTERIOR

APPROVED SUBJECT TO COMPLIANCE WITH THE CITY OF WARRAMANGA WATER SUPPLY AND SEWERAGE BY-LAWS AND SUBJECT TO THE CITY ENGINEERING MANUAL


Approval GRANTED as to External Design and Siting  
*[Signature]*  
 Delegates  
 NATIONAL CAPITAL DEVELOPMENT COMMISSION

<b>BLK 4 SECT 8 WARAMANGA</b>	
WORK SHALL CONFORM ALSO TO THE SPECIFICATIONS, OTHER DRAWINGS, JOB DIMENSIONS AND ALSO TO ALL REQUIREMENTS OF THE BUILDER. ANY SHOP DRAWINGS NECESSARY FOR THIS WORK SHALL BE SUBMITTED TO THE ARCHITECTS AND SIGNED BY THEM BEFORE WORK IS COMMENCED.	
<b>ORLIT PTY. LTD.</b>	
<b>SITE PLAN</b> SEC 8	<b>HOUSES</b> SECTIONS 8, 12 & 13 WARAMANGA
<b>LEITH &amp; BARTLETT PTY. LTD.</b> ARCHITECTS, ENGINEERS, TOWN PLANNERS 220 NORTHBOURNE AVE, BRADDOON, 2401, A.C.T. TELEPHONE 47 6077	Drawn: <i>[Signature]</i> Date: 24.9.69 Scale: 1:400
	Job No. <b>69110</b> Drawing No. <b>1</b>


S/R

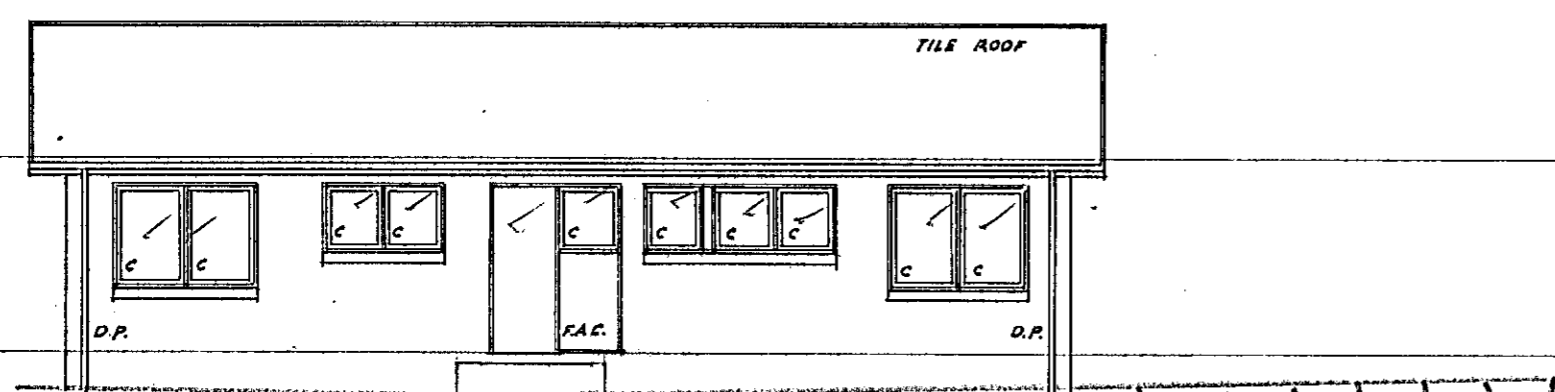

ELEVATION 3

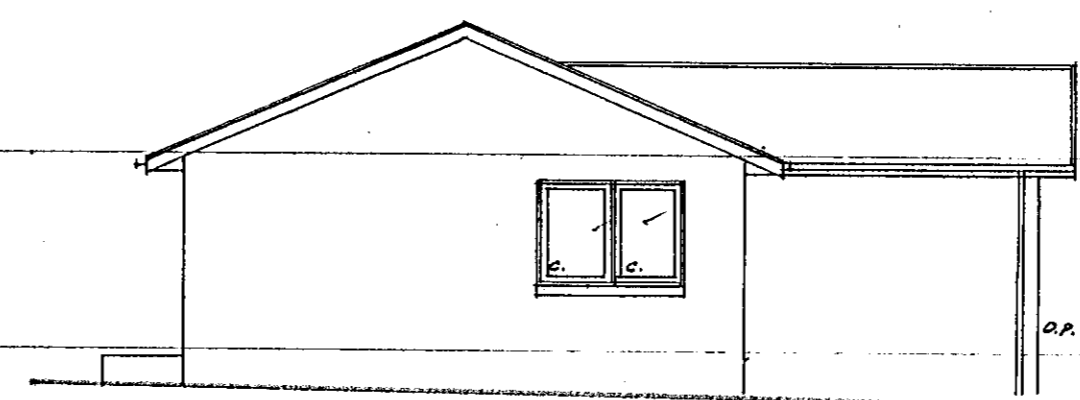


ELEVATION 4

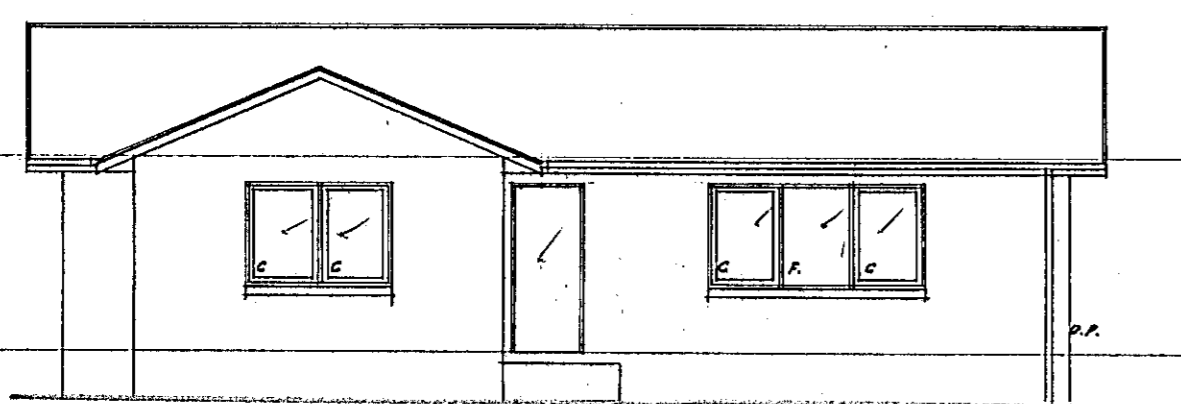


ELEVATION 1


N.B. LIGHT AREAS TO ALL HABITABLE ROOMS  
TO BE 12 sq ft or 1/8 of the FLOOR AREA  
WHICH EVER IS THE GREATER.

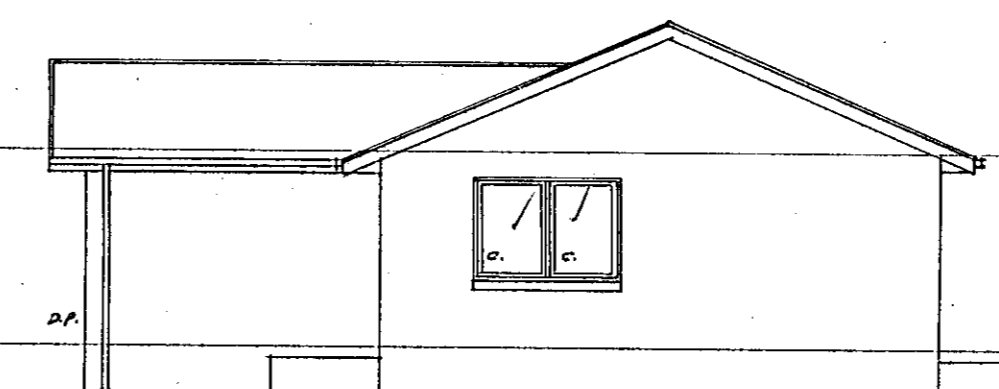

ELEVATION 2

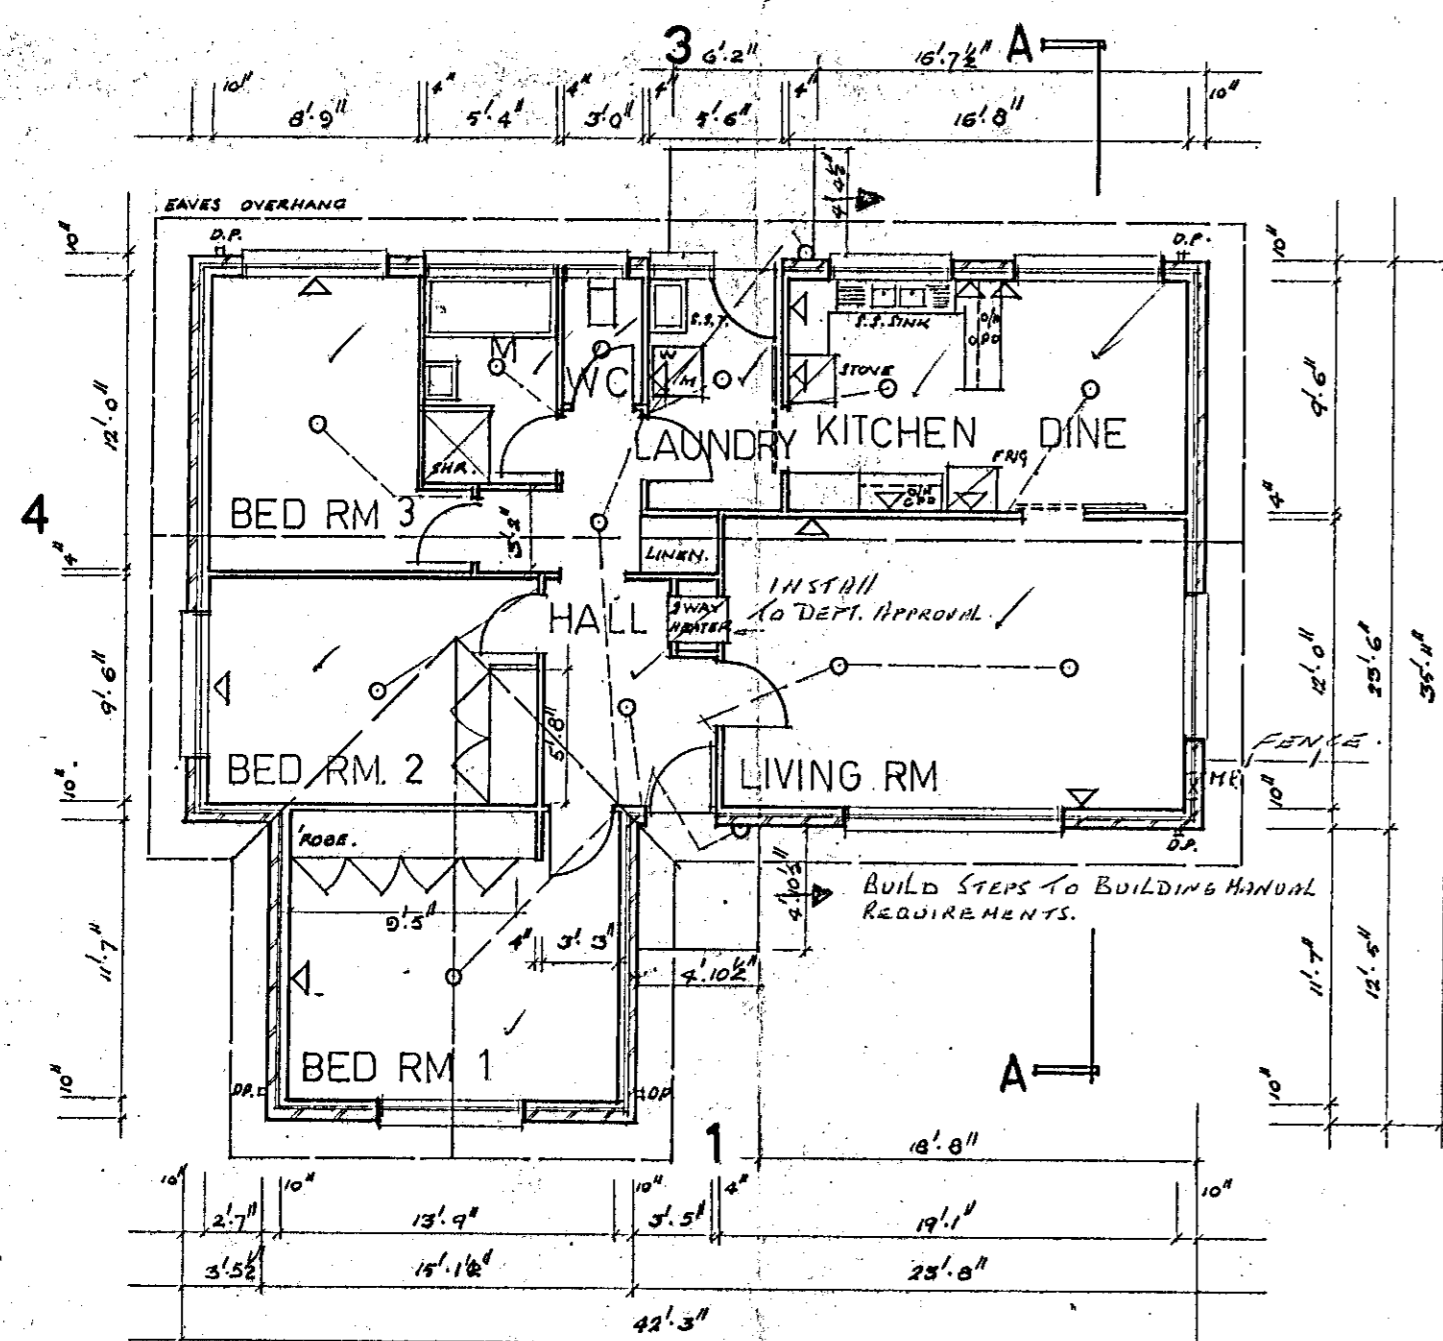

FLOOR PLAN AT 1" = 8'-0"  
HOUSE TYPE 'STROMLO'

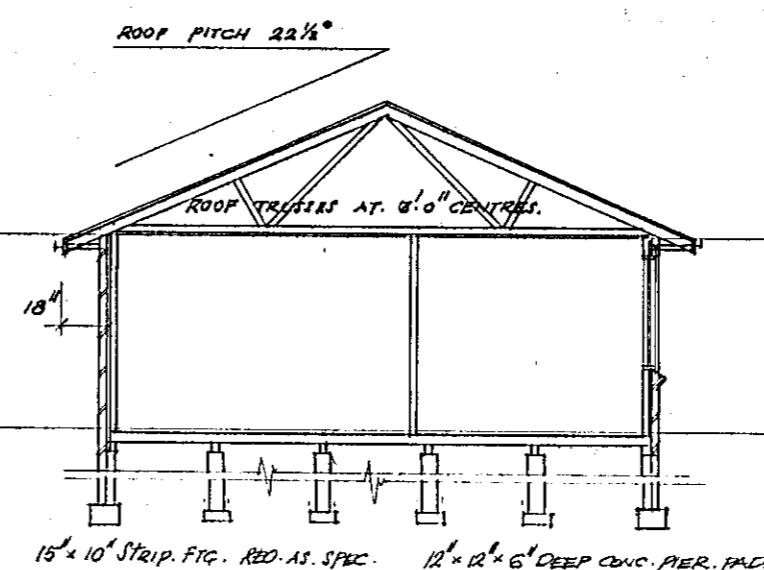

SECTION A-A

ELECTRICAL LEGEND

LIGHT OUTLET AND SWITCH   
GENERAL PURPOSE POWER OUTLET

APPROVED SUBJECT TO THE CANBERRA SUPPLY REGULATIONS

EXCEPT WHERE SUBJECT TO AND OVERSEEN BY THE BUILDING MANUAL

PLANS AND SPECIFICATIONS EXAMINED AND RECOMMENDED FOR APPROVAL  
BY *James 15/10/69*  
ENGINEER FOR WATER SUPPLY AND SEWERAGES  
*J. Lowe 24/10/69*  
CHIEF ELECTRICAL ENGINEER

STRUCTURAL ENGINEER  
*J. Brown 5/11/69*  
ARCHITECT AND VALUER  
*27 OCT 1969*

APPROVED - PROPER AUTHORITY  
DEPUTY PROPER AUTHORITY  
UNDER BUILDING ORDINANCE 1964-69

Approval GRANTED as to External Design and Siting  
14 OCT 1969  
DATE  
Delegato  
NATIONAL CAPITAL DEVELOPMENT COMMISSION

2.	26.6.69	PORCH ON ELEVATION 3 AMENDED	G.S.
1.	29.5.69	KITCHEN FITTINGS RESITED; CAVITY WALL RESITED; BACK PORCH INCREASED; DIMENSIONS ADDED	G.S.
NO.	DATE	AMENDMENT	BY


WORK SHALL CONFORM ALSO TO THE SPECIFICATIONS, OTHER DRAWINGS, JOB DIMENSIONS AND ALSO TO ALL REQUIREMENTS OF THE BUILDER. ANY SHOP DRAWINGS NECESSARY FOR THIS WORK SHALL BE SUBMITTED TO THE ARCHITECTS AND SIGNED BY THEM BEFORE WORK IS COMMENCED.

AREA	block no.	section
1175	4	8 WARAMANGA
CONTRACTORS MUST VERIFY ALL DIMENSIONS AT THE JOB BEFORE COMMENCING ANY WORK OR MAKING ANY SHOP DRAWING		
DRAWN M.J.C.	CLIENT	JOB No.
DATE 30-1-69	ORLIT PTY. LTD.	68107
CHECKED	JOB	DRAWING No.
DATE	HOUSE V. 326 STROMLO	1
SCALES	WORKING DRAWING	DATE PRINTED
1" = 8'-0"		30-1-69

LEITH & BARTLETT PTY. LTD.  
DIRECTED BY ARCHITECTS, ENGINEERS, TOWN PLANNERS  
458 ST. KILDA ROAD, MELBOURNE, S.C.2 26-2482



ENGINEER FOR WATER SUPPLY AND SEWERAGE 7/29  
 CHIEF ELECTRICAL ENGINEER 7/34  
 STRUCTURAL ENGINEER 7/18  
 ARCHITECT AND VALUER 5/1 " 21/8 67  
 27 OCT 1969  
 APPROVED 5/1 " 21/8 67  
 DEPUTY PROPER AUTHORITIES  
 UNDER BUILDING ORDINANCE 1954-55

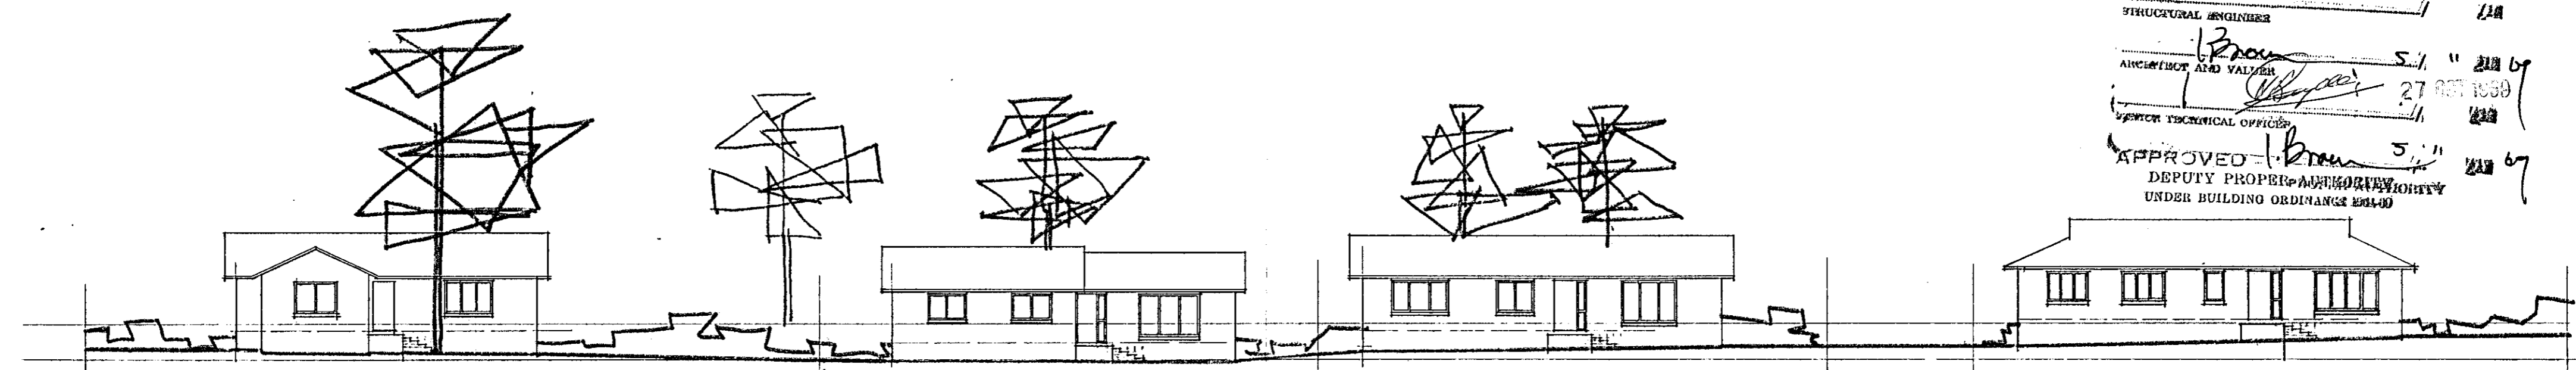


9/8 STROMLO  
 BRICK BASE :  
 BRICK TOP :  
 ROOF COLOUR :

5/8 MOLONGLO R  
 BRICK BASE :  
 BRICK TOP :  
 ROOF COLOUR :

7/8 FRANKLIN R  
 BRICK BASE :  
 BRICK TOP :  
 ROOF COLOUR :

FOOT PATH 6/8 CORIN R (DG)  
 BRICK BASE :  
 BRICK TOP :  
 ROOF COLOUR :

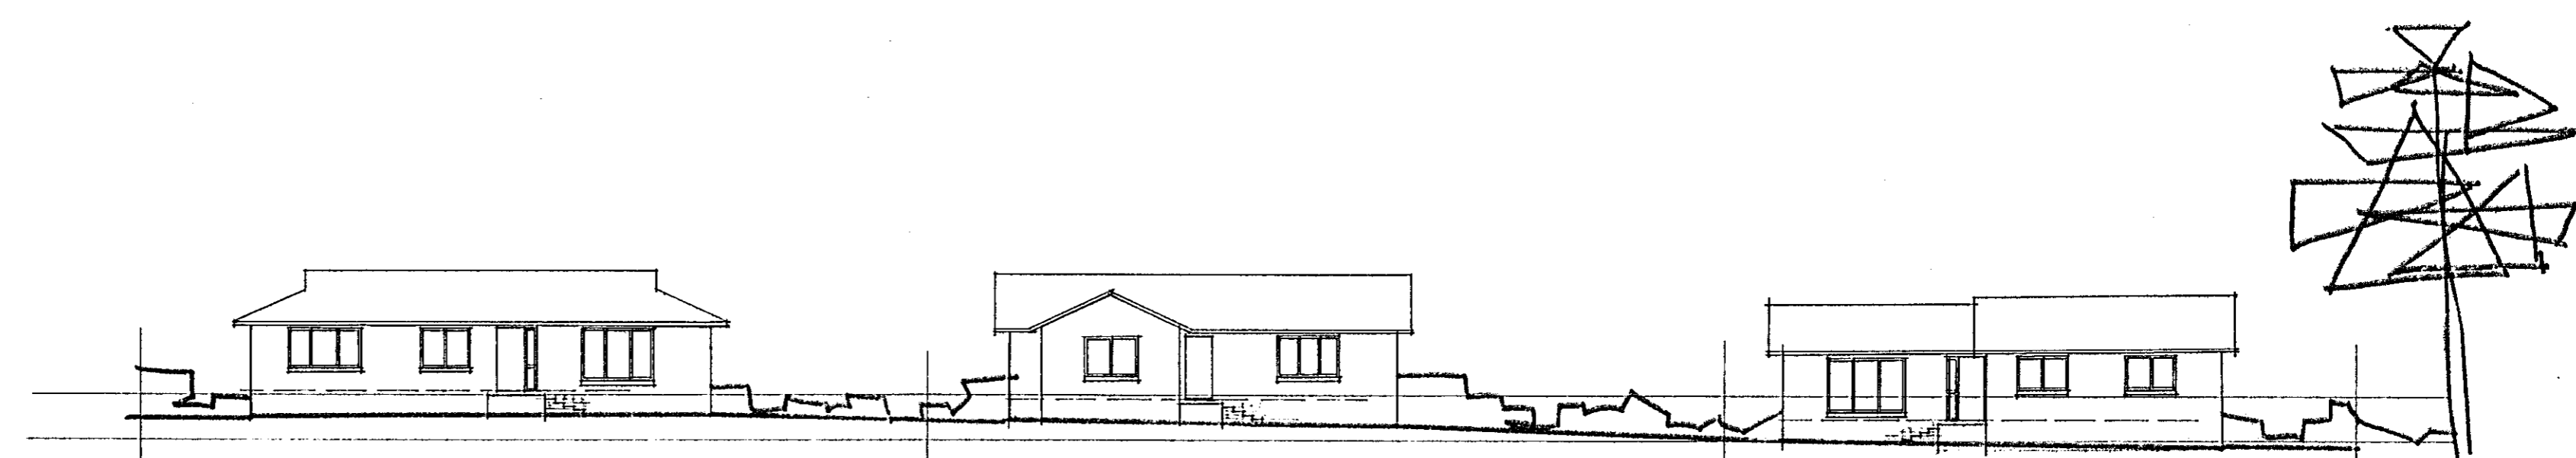

5/8 FRANKLIN R (DG)  
 BRICK BASE :  
 BRICK TOP :  
 ROOF COLOUR :

4/8 STROMLO  
 BRICK BASE : Buff  
 BRICK TOP : Buff  
 ROOF COLOUR : Grey-Green  
 Windows : Aluminium

5/8 MOLONGLO R  
 BRICK BASE :  
 BRICK TOP :  
 ROOF COLOUR :

Approval GRANTED as to External Design  
 and Siting  
 Delegate  
 NATIONAL CAPITAL  
 DEVELOPMENT COMMISSION  
 DATE

**BLK 4 SECT 8 WARAMANGA**

WORK SHALL CONFORM ALSO TO THE SPECIFICATIONS, OTHER DRAWINGS, JOB DIMENSIONS AND ALSO TO ALL REQUIREMENTS OF THE BUILDER. ANY SHOP DRAWINGS NECESSARY FOR THIS WORK SHALL BE SUBMITTED TO THE ARCHITECTS AND SIGNED BY THEM BEFORE WORK IS COMMENCED.

**ORLIT PTY. LTD.**

**STREET ELEVATION SECTION 8**

**HOUSES SECTIONS 8, 12 & 13 WARAMANGA**

LEITH & BARTLETT PTY. LTD. ARCHITECTS, ENGINEERS, TOWN PLANNERS  
 210 NORTHBOURNE AVE, BRADDON, 2601, A.C.T.  
 TELEPHONE 49 477

Drawn: [Signature]  
 Date: 27.9.69  
 Scale: 1:1500

Job No.: 69110  
 Drawing No.: 3

Department of the Capital Territory  
Building Section

Australian Capital Territory  
Building Ordinance 1972-74  
(Part V)

**CERTIFICATE OF FITNESS**

(CLASS Y AND X OCCUPANCY ONLY)

BL1/8(9/75)

It is hereby certified that the building consisting of.....METAL GARAGE.....

..... situated on

Block  <u>4</u>	Section  <u>8</u>	Division  <u>WARANINGA.</u>
-----------------------	-------------------------	-----------------------------------

or situated at

for which plans and specifications were approved and a Building Permit issued under the provisions of the Building Ordinance 1972, is fit for use and/or occupation.

Approved plan no.

(1977)A.

Type of construction*	Class of occupancy*	Number of storeys
-----------------------	---------------------	-------------------

Permit no.  <u>17003</u>	Name of permit holder  <u>BODDY &amp; COLLINS</u>
--------------------------------	---------------------------------------------------------

\*As defined in the Building Manual  
A.C.T.

NO

3085

[Signature]  
Deputy Building Controller

10/9/76

GARAGES

CARPORTS

GARDEN SHEDS



**BODDY & COLLINS Pty Ltd.**

289 CANBERRA AVENUE, FYSHWICK 2609 A.C.T.

P.O. BOX 328  
FYSHWICK

HOLIDAY HOMES

Telephone :  
95 0648

Proposed siting for a garage/carport-shed to be erected for

Mr BOSCHERT of 34 MALARA ST.

on Block 4 Section 8 Suburb WARAMANGA

Size 9700 x 6100 x 2100

Builder to erect unit and \_\_\_\_\_

PLANS/FILE No. 19770/A  
Received Building Section  
20 JUL 1976 51/2  
Dept. of the Capital Territory


Owner to level and prepare site, encase stormwater and/or sewerage line  
if found to be necessary.

SITE PLAN.

Scale: 1 : 500

The proposed structure shown on this plan has  
been sited in accordance with the provisions of the  
Ordinance, and may be erected on the site indicated.

*J. Rowe*  
CHIEF ELECTRICAL ENGINEER  
A. C. T. E. A.

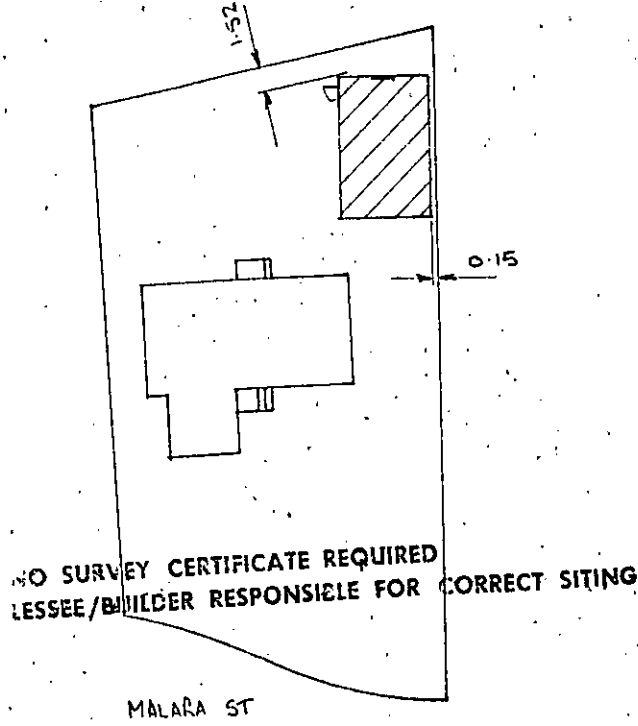

BUILDINGS (DESIGN AND SITING)  
ORDINANCE 1964 AS AMENDED  
APPROVAL GRANTED

DELEGATE

4 AUG 1976

*J. Rowe*

NATIONAL CAPITAL  
DEVELOPMENT COMMISSION





# CERTIFICATE OF OCCUPANCY OR USE

Pursuant to Part V of the Building Ordinance 1972, the building consisting of:

Pergola

situated at

Block <b>4</b>	Section <b>8</b>	Division <b>Woramanga</b>
or situated at		

is considered to be substantially in accordance with the prescribed requirements for occupancy and use, subject to the endorsements listed below.

Approved plan Nos. <b>19770/B</b>		
Type of construction* <b>N/A</b>	Class of occupancy* <b>10</b>	(*as defined in the Building Manual A.C.T.)
Permit No. <b>104779</b>	Name of permit holder <b>C. Borg</b>	

Endorsements

.....

.....

The issue of this Certificate does not affect the liability of a person to comply with the provisions of a law of the Territory (including the Building Ordinance) relating to the building work nor does it authorise the use of the land contrary to a provision, covenant or condition of lease.

070253

*[Signature]*  
 Page 47 of 80  
 Deputy Building Controller

**27/10/88**  
 date

SEE OVERLEAF





# ACT Planning and Land Authority

GPO Box 1908, Canberra ACT 2601

## Certificate of Occupancy and Use

Certificate No. **104171N1C1**

This Certificate is issued in accordance with Section 69 (3) of the Building Act. On successful completion of all of the building work this certificate will be cancelled.

The part of the building work listed on this certificate has been completed substantially in accordance with the prescribed requirements and is considered fit for occupation and use.

Builder <b>JEREMY COOPER</b>	Suburb <b>WARAMANGA</b>	Section <b>8</b>	Block <b>4</b>
Notice of Intention to Start Work Number <b>104171N1</b>	Plan <b>104171/A</b>		

### Building Work

Nature of Work	Project Item Description	Unit	Other Description	Class of Occupancy	Type of Construction
ALTERATIONS TO	DA EXEMPT-RESIDENCE		AND ADDITIONS INCLUDING REAR PERGOLA, DECK & FRONT PERGOLA	1a(i) & 10	NA

### Comments

THIS IS A PARTIAL CERTIFICATE FOR INTERNAL ALTERATIONS ONLY. FRONT & REAR PERGOLAS & DECK NOT ERECTED.

### Important note:

1. Residential building statutory warranties and residential insurance does not apply in relation to building work.
2. The issue, under this Part, of a certificate in respect of a building or portion of a building does not affect the liability of a person to comply with the provisions of a law of the Territory (including this Act) relating to the building or portion of the building.

SARAH RADFORD  
Delegate of the Registrar

15/12/2011

Date

# Additions & Alterations Block 4 Section 8 Waramanga

**ASSET CERTIFIERS**  
Building certifiers, building safety & fire safety consultants

**BUILDING APPROVAL (BA)** issued under s 28 of the Building Act 2004.  
Certifier name: **MICHAEL COLLINS**  
License Number: **200698**  
BCA Occupancy Class: **Class 1a(i) & 10a**  
BCA Type of Construction: **NA**  
Issue date: **04/09/2010**

*Michael Collins*  
Certifier signature

Page 1 of 7

## List of Proposed

Refer to drawings sheets A100

1. Kitchen renovated.
2. Bath renovated.
3. Walls removed between existing kitchen and living.
4. Existing windows replaced with new windows.
5. Sliding door access to from dining to rear.
6. Pergola over entry.
7. Pergola over rear.
8. Existing external masonry rendered.

Plan No: 104171/A

09 SEP 2010

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ACT Planning & Land Authority

## Drawing List

- A001 Site Plan
- A100 Floor Plan
- A200 Elevations
- A300 Notes & Window Schedule
- A400 Demolition Plan
- A401 Demolition Notes

**NOTE:**

Connect 90mm UPVC storm water line to storm water tie.  
Exact location of storm water tie to be confirmed by builder prior to construction.

Block boundaries & contours easements to be verified on site prior to construction.

Retaining wall heights to suit site conditions final height to be confirmed by builder.

SITE AREA: 781.57m<sup>2</sup>  
Existing Living Area: 109.69m<sup>2</sup>  
Existing Garage Area: 58.50m<sup>2</sup>  
Total Living: 109.69m<sup>2</sup>

Max Plot Ratio: 50% - 390.79m<sup>2</sup>  
ACHIEVING PLOT RATIO  
21.52% - 160.19m<sup>2</sup>

Open Space Requirements:  
60% site area less 50sqm required: 418.94m<sup>2</sup>  
ACHIEVING: 621.38m<sup>2</sup>

10% of block area to have a minimum dimension of 6m required: 78.16m<sup>2</sup>  
ACHIEVING: 270.79m<sup>2</sup>


Erosion & Sediment  
"To comply with best practice guidelines prevent pollution from residential building sites, March 2006."

The development will comply with the ACT Environment Protection Authority, Environment Protection Guidelines for Construction and Land Development in the ACT, August 2007.

**ASSET CERTIFIERS**  
Building, electrical, plumbing, gas & fire safety consultants

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*Michael Collins*  
Certifier signature  
Page 2 of 7

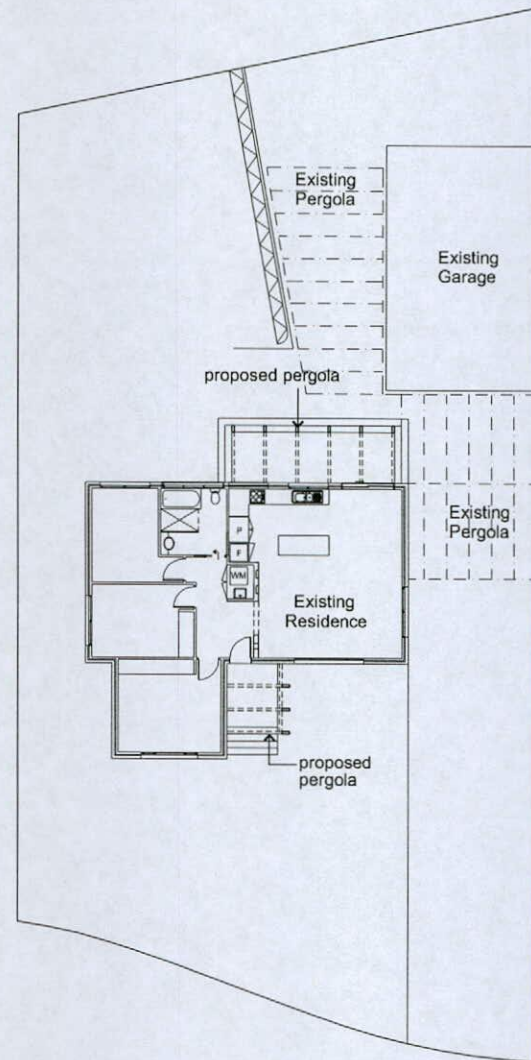



Plan No: 10471/A  
09 SEP 2010  
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Site Plan.

PROJECT:  
Additions & Alterations  
Block 4  
Section 8  
WARAMANGA

CLIENT: Cooper Residence	DESIGNED: AC	DATE: 29-7-10	JOB No:	REV:
	DRAWN: AC	Scale: 1:200@A3	DRAWING STATUS: DEVELOPMENT APPLICATION	
DRAWING TITLE: SITE PLAN			DWG No: A001	
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Plan No: 104171/A  
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**ASSET CERTIFIERS**  
 Building certifier & building code & fire safety consultants

**BUILDING APPROVAL (BA)**  
 issued under s 28 of the Building Act 2004.  
 Certifier name: **MICHAEL COLLINS**  
 License Number: **200698**  
 BCA Occupancy Class: **Class 1a(i) & 10a**  
 BCA Type of Construction: **NA**  
 Issue date: **04/09/2010**

*Michael Collins*  
 Certifier signature  
 Page 3 of 7

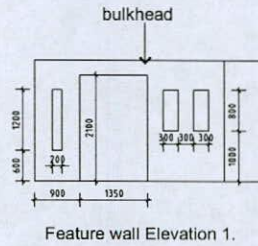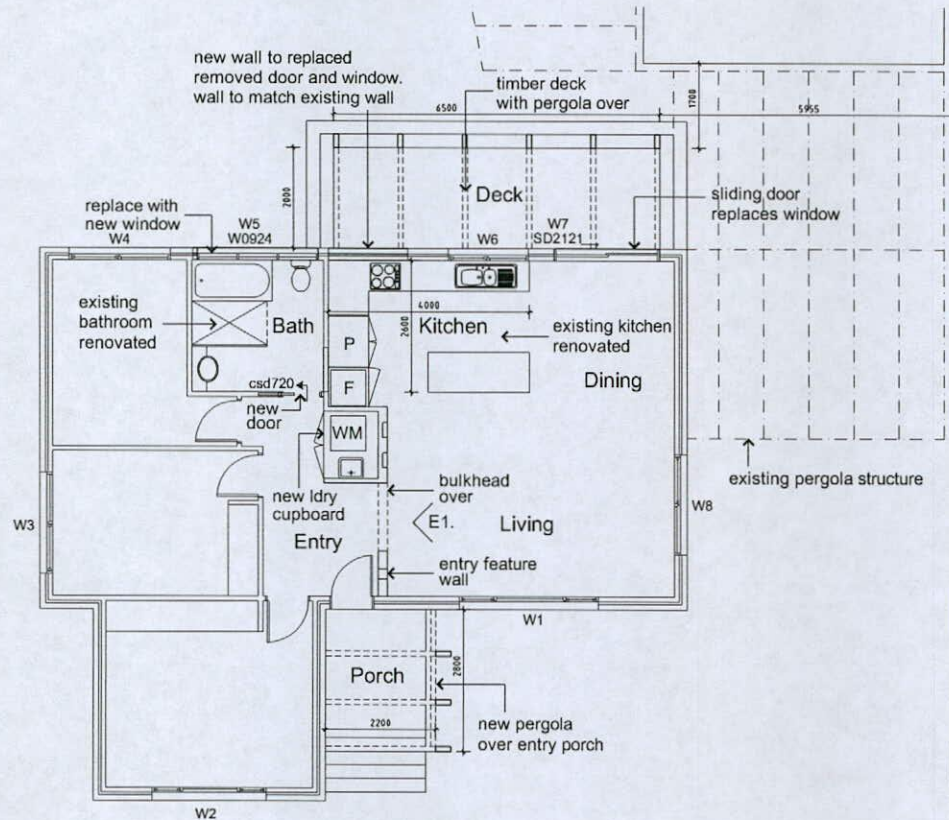**NOTE:**  
 all dimensions to be checked & verified on site prior to any construction.

Where demolition work is carried out ensure that adequate structural support is provided to maintain the integrity of existing structure prior to removing any existing building element.

All materials to match existing  
 Maintain cavity construction

The development will comply with the ACT Environment Protection Authority, Environment Protection Guidelines for Construction and Land Development in the ACT, August 2007.


4. 1.

Floor Plan.

PROJECT:  
 Additions & Alterations  
 Block 4  
 Section 8  
 WARAMANGA

CLIENT: Cooper Residence	DESIGNED: AC	DATE: 29-7-10	JOB No:	REV:
	DRAWN: AC	Scale: 1:100@A3	DRAWING STATUS: DEVELOPMENT APPLICATION	
DRAWING TITLE: FLOOR PLAN			DWG No:	A100

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Elevation 1.

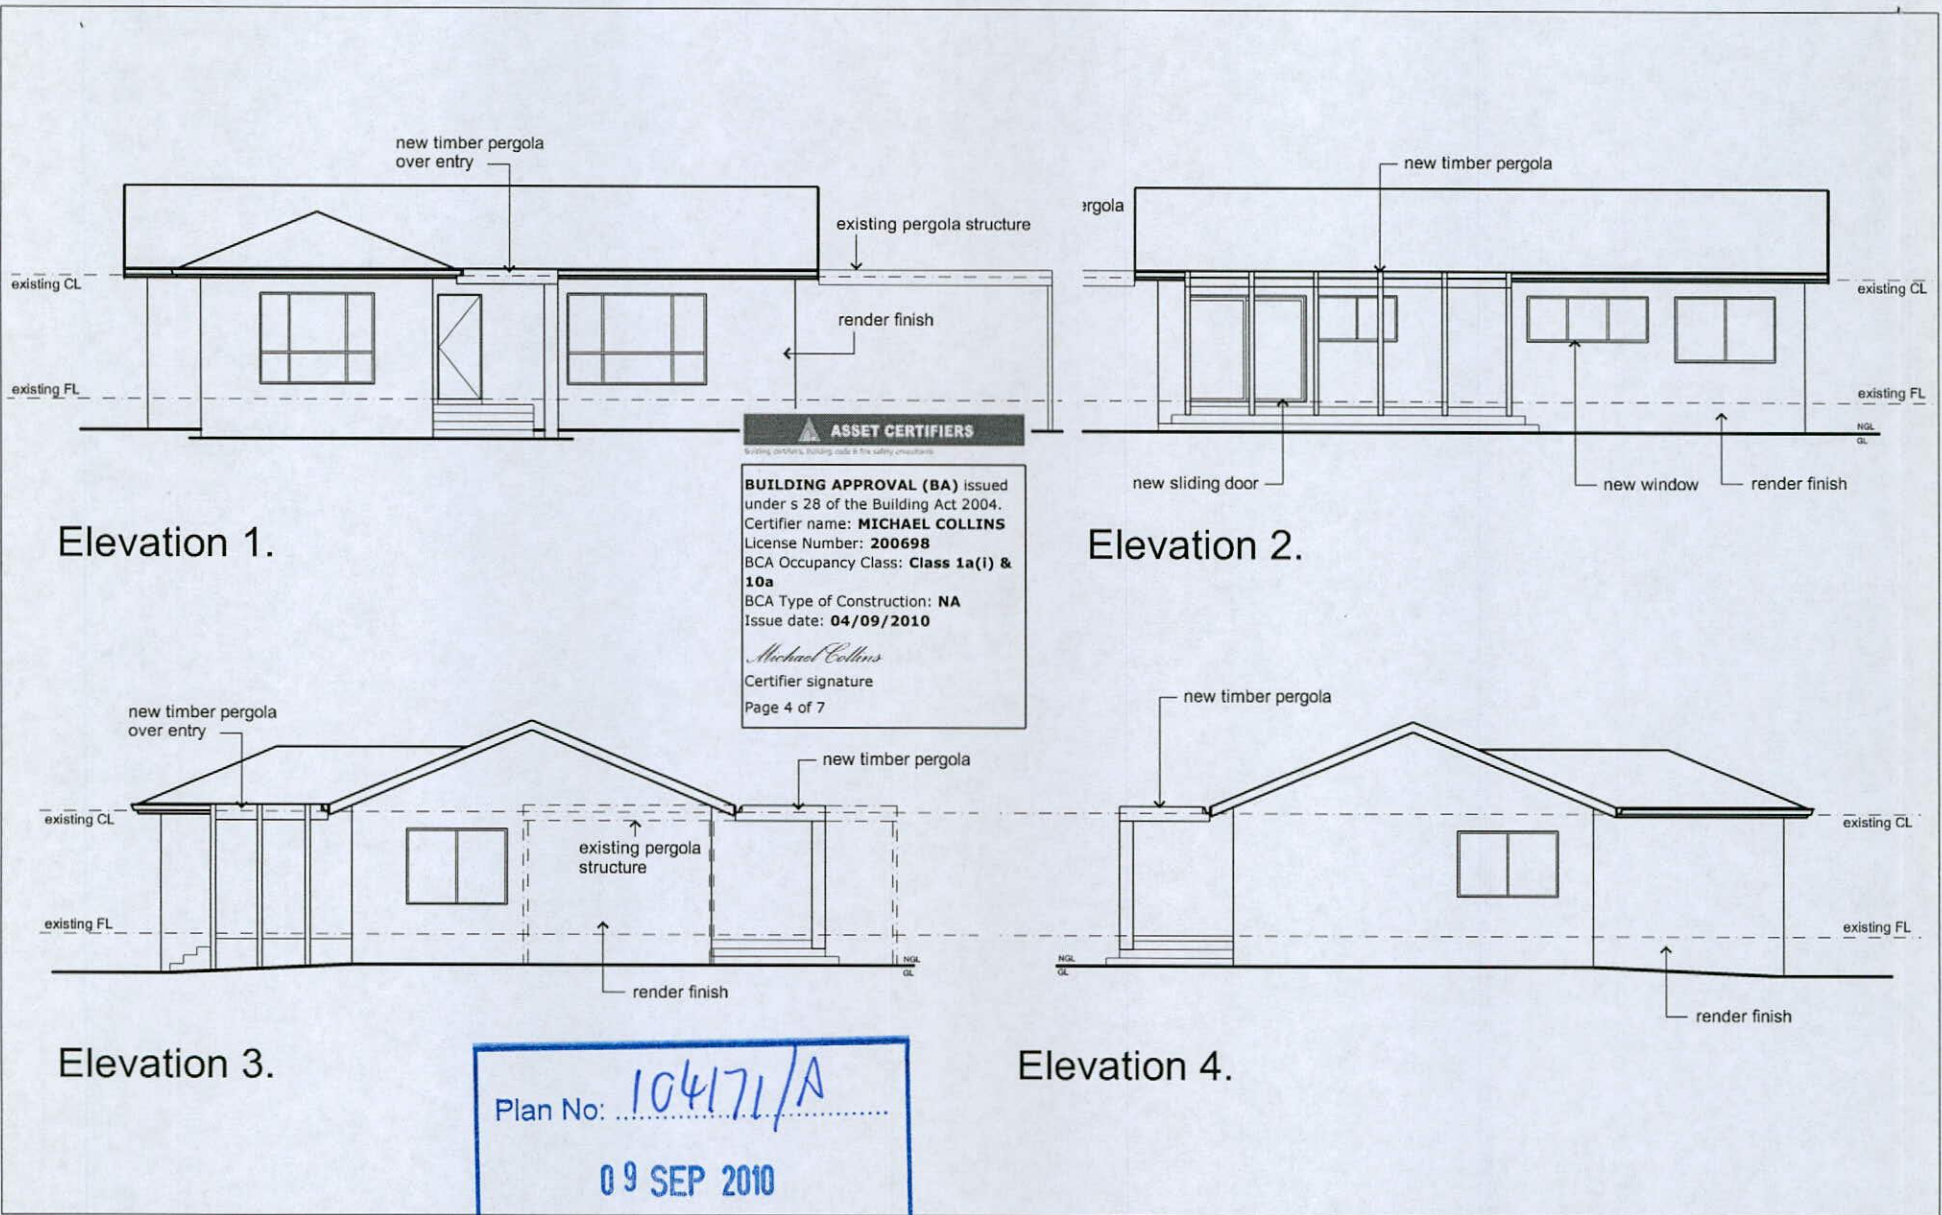Elevation 2.

Elevation 3.

Elevation 4.

Plan No: 104171/A  
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 ACT Planning & Land Authority

PROJECT:  
 Additions & Alterations  
 Block 4  
 Section 8  
 WARAMANGA

CLIENT: Cooper Residence	DESIGNED: AC	DATE: 29-7-10	JOB No:	REV:
	DRAWN: AC	Scale: 1:100@A3	DRAWING STATUS: DEVELOPMENT APPLICATION	
DRAWING TITLE: ELEVATIONS			DWG No:	A200
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**NOTES**

**General**

Builder to provide all labour, materials, fittings, plant, tools, permits, insurances etc necessary for the proper completion of the work and ensure that all labour and materials in all trades are the best of their respective kinds.

Builder is to visit the site and inform himself of scope of work prior to commencing.

Follow figured dimensions on the drawings. Check and verify dimensions prior to starting any work.

Building setbacks and dimensions to be verified by surveyor prior to commencing any work.

Materials and workmanship to be in accordance with the Building Code of Australia, the A.C.T. Appendix and all other relevant codes.

Builder shall be responsible for the general water tightness of the entire works in all trades.

Footings  
Footings to be in accordance with AS 2870 part 1

Footings to be taken down to solid ground.

Brickwork  
Brickwork to match existing

Generally 230x110x76mm bricks bonded in stretcher bond.

Mortar to comply with the requirements of relevant SAA codes. cement mortar:

- 6 part sand
- 1 part cement
- 1 part lime

**LINTELS FOR BRICKWORK**

Where spans are up to 1500mm provide 150mm bearing onto brickwork.

Where spans are over 1500mm provide 230mm bearing onto brickwork.

Where steel angles are used ensure that the longer leg is placed vertical.

Span of opening	Lintel
up to: 1200mm	76x10mm bar
1201 to 1500mm	76x76x10 angle
1501 to 2400mm	127x76x10 angle
2401 to 3000mm	152x89x10 angle

Provide damp proof course at bearer seating level

Provide stepped cavity flashing with weep holes at 1200mm centres to the external brick skin at ground floor level, under window sills and in brickwork above windows.

External Steps to be 75mm reinforced concrete.  
Riser: 172mm Going: 265mm min. unless otherwise noted.

Concrete Slab  
Reinforced Concrete slab on ground to be constructed in accordance with AS 2870.1

Provide clean well consolidated fill under slab as required.

Where fill exceeds 400mm provide 230mm X 230mm brick piers on 400x400x250mm concrete pads at 1500 ctrs. with 2 layers (top&bottom) of reinforcing fabric in slab above piers.

0.2mm polyethylene moisture barrier under concrete slab.

Provide reinforced concrete strip footing or thickening in slab under load bearing walls as per AS 2870.1

**Timber Floor**

All timberwork to comply with the requirements of AS 1684 National Timber Framing Code

20mm (nom) structural board sheet flooring

100x38 H.W Joists at 450 ctrs or 100x50 F7 oregon joistd may be used.

100x75 HW Bearers on 230mm o brick piers at 1500 ctrs max. altnatively 100x50F7 oregon Bearers may be used

where brick piers are not used 250 x 50 F7 oregon joists at 450 ctrs for spans not exceeding 4500mm may be used.

Floor beams as indicated as directed by engineer.

**Timber Stud work**

All timberwork to comply with the requirements of AS 1684 National Timber Framing Code

90x35 Pine plates and nogging. Provide second 90x45 top plate to all load bearing walls.

90x35 pine studs at 450 ctrs to all load bearing walls and at 600 ctrs to non-load bearing walls.

Provide 90x45 f8 studs to both sides of openings carrying lintels  
F8 timber to walls supporting trusses with spans greater than 6 m.

50x38mm ceiling battens at 450 ctrs.

10mm Plasterboard wall and ceiling lining.

Fibrous cement sheet wall lining to eaves.

Roof  
Trusses at 900mm ctrs. fixed to manufacturers specifications.

Lintel size to truss manufacturers charts.

Roof pitch to match existing  
Roof tiles as selected.

Fascia and gutter as selected.

**Plasterer/Internal Linings**

Wall framing to all rooms to be covered with close joint linings: the joints being backed with either noggings or studs as required by manufacturer. All linings shall be securely fixed.

Plasterboard (min 10mm thick) wall and ceiling lining

Fibrous cement sheet wall lining to wet areas.

Provide cornice or as selected shall be fixed at intersections of all beam and wall junctions with ceilings.

Drainage and Plumbing  
Provide all necessary drainage required for the discharge and connection to appropriate ties of sewerage, stormwater and other drainage services as required for the proper functioning of the facilities as required by the appropriate Authorities.

Provide all agricultural drains as required to divert water and moisture which may cause seepage to the building structure.

Provide all necessary plumbing materials and service required for the proper operation of all sanitary fixtures and fittings, water supply and reticulation, roof plumbing, flashings and the like as necessitated by the works.

**Painter**

Provide all painters work as required by the builder and as necessitated by the nature of the job. Work to be finished in the best manner, ensure surfaces are smooth and perfectly conditioned to take the applied finish.

Electrical  
Supply erect and connect all necessary material to complete the electrical installation for its full satisfactory operation and in accordance with authorities requirements, relevant codes and regulations and as directed by the builder.

Forward all notices, arrange for all inspections as required by the relevant Authorities.

Smoke alarms are to be installed in accordance with BCA, Building note 19 and to comply with AS 3786. Smoke alarms are to be connected to mainspower with battery back, and wired in accordance with AS 3000.

**Windows**

Provide all necessary materials, fixings, frames, glazing, fly screens and the like conforming to all relevant trade practices and codes. Ensure the correct operation of windows, sliding doors and the like, ensuring correct protection from water and the like.

External  
Ground levels, and steps are approximate only. Actual ground/site conditions to be verified prior to construction.

Fibrous cement sheet linings to eaves.

Landing on brick walls to be 100mm thick reinforced with 1 layer f718 mesh.

Brick courtyard walls to be 1800mm high, 230mm brickwork up to 500mm high above ground level and 110mm brickwork with engaged piers at 1500ctrs up to 1500mm height max.

Provide yard sumps as required.

All roof skylights are to be a minimum distance of 1000mm from any adjoining unit boundary.

**ASSET CERTIFIERS**  
Building certifiers, building survey & fire safety professionals

**BUILDING APPROVAL (BA)** issued under s 28 of the Building Act 2004.  
Certifier name: **MICHAEL COLLINS**  
License Number: **200698**  
BCA Occupancy Class: **Class 1a(i) & 10a**  
BCA Type of Construction: **NA**  
Issue date: **04/09/2010**

*Michael Collins*  
Certifier signature

Page 5 of 7

Plan No: **10471/A**

**09 SEP 2010**

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**ACT Planning & Land Authority**

Window Schedule

W1	1800x2600	single glazed	aluminium frame	existing
W2	1800x2260	single glazed	aluminium frame	existing
W3	1450x1800	single glazed	aluminium frame	existing
W4	1450x1800	single glazed	aluminium frame	existing
W5	0900x2400	single glazed	aluminium frame	NEW
W6	1020x1545	single glazed	aluminium frame	existing
W7	2100x2100	single glazed	aluminium frame	NEW
W8	1450x1550	single glazed	aluminium frame	existing

PROJECT:  
**Additions & Alterations  
Block 4  
Section 8  
WARAMANGA**

CLIENT: <b>Cooper Residence</b>	DESIGNED: <b>AC</b>	DATE: <b>29-7-10</b>	JOB No:	REV:
	DRAWN: <b>AC</b>	Scale: <b>1:100@A3</b>	DRAWING STATUS: DEVELOPMENT APPLICATION	
	DRAWING TITLE: <b>NOTES &amp; WINDOW SCHEDULE</b>		DWG No: <b>A300</b>	

**NOTE**


Where demolition work is carried out ensure that adequate structural support is provided to maintain the integrity of existing structure prior to removing any existing building element.

----- Walls, doors and windows to be demolished


**ASSET CERTIFIERS**  
Building Certifiers, Building work & fire safety consultants

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 Certifier name: **MICHAEL COLLINS**  
 License Number: **200698**  
 BCA Occupancy Class: **Class 1a(i) & 10a**  
 BCA Type of Construction: **NA**  
 Issue date: **04/09/2010**

*Michael Collins*  
 Certifier signature  
 Page 6 of 7

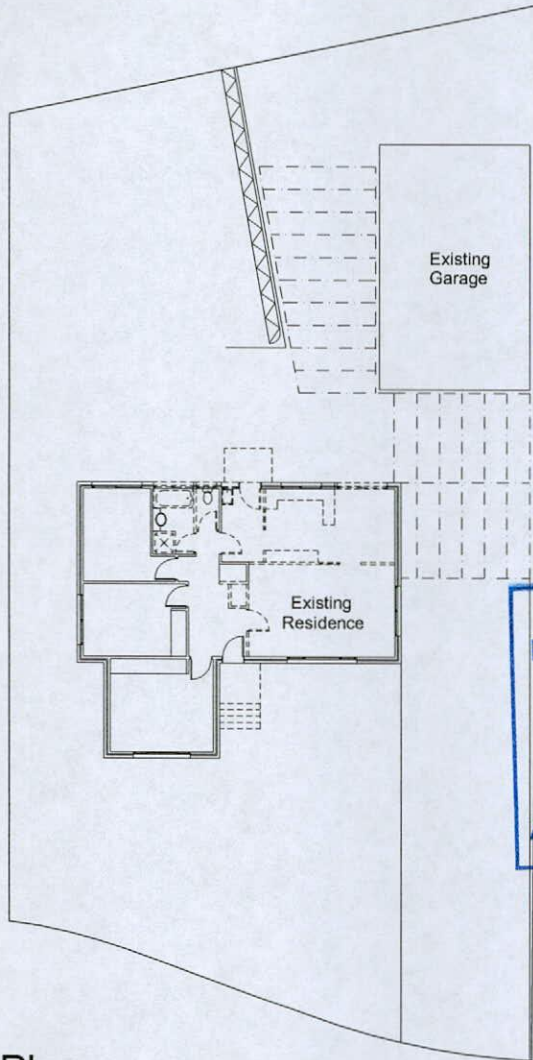

Site Plan.

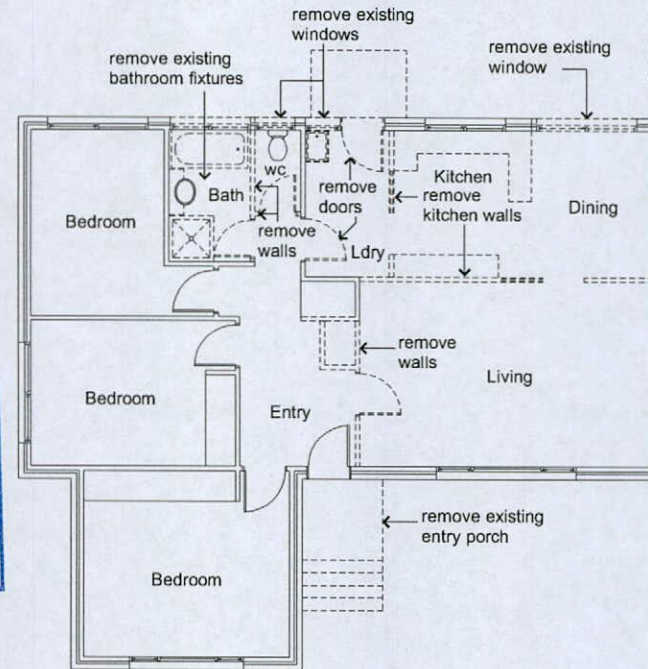

Floor Plan.

Plan No: 104771/A  
 09 SEP 2010  
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 ACT Planning & Land Authority

PROJECT:  
 Additions & Alterations  
 Block 4  
 Section 8  
 WARAMANGA

CLIENT: Cooper Residence	DESIGNED: AC	DATE: 29-7-10	JOB No:	REV:
	DRAWN: AC	Scale: 1:100@A3	DRAWING STATUS: DEVELOPMENT APPLICATION	
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**NOTES**

**General**

Builder to provide all labour, materials, fittings, plant, tools, permits, insurances etc necessary for the proper completion of the work and ensure that all labour and materials in all trades are the best of their respective kinds.

Builder is to inform himself of all site conditions and scope of work prior to commencing. All necessary allowances are to be included such as costs associated with demolition making good, matching existing detail, travelling costs and the like as required for the satisfactory completion of the alterations whether expressly indicated or not and as necessitated by site conditions.

Where adjustments are required to suite site conditions consult client for approval.

Materials and workmanship to be in accordance with the Building Code of Australia, the ACT. Appendix, and all other relevant codes.

**DEMOLITION**

Provide all necessary demolition work required for the proper completion of the renovations, alterations and all other associated works.

Where demolition work is carried out ensure that adequate structural support is provided to maintain the integrity of existing structure prior to removing any existing building element.

Protect materials and property from damage. Make good existing work that has been damaged. New detail to match existing where appropriate and, unless otherwise directed, new finish to blend into adjacent surfaces.

Services: Where existing services are to be modified, disconnected, or relocated ensure that all redundant services are made safe.

**Standard**

To AS 2601.

**MATERIALS AND COMPONENTS**

**Hazardous materials**

Give notice immediately any hazardous materials or conditions are found.

**Demolished materials**

Except for materials as directed by the client to be salvaged or re-used, demolished materials are the property of the contractor and must be removed from the site. Do not burn or bury demolished materials on the site.

Salvage: Recover materials to be salvaged or re-used without damage.

Re-use: Re-use only materials recovered from the demolitions in a sound and suitable condition.

Storage: Store in an approved location any materials to be re-used.

Removal: Cover materials in transit to prevent spillage.

**Support**

Provide temporary support for sections of existing buildings which are to be altered and which normally rely for support on work to be demolished. Support until permanently supported on new work. Clear away temporary supports on completion.

Ground support: Support excavations for demolition of underground structures.

**Weather protection**

If walls or roofs are opened for alterations and additions or the surfaces of adjoining buildings are exposed, provide temporary covers to prevent water penetration. Provide covers to protect existing plant and equipment and materials intended for re-use.

**Dust protection**

Provide dust-proof screens, bulkheads and covers to protect existing finishes and the immediate environment from dust and debris.

**Explosives**

Do not use explosives.



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 Certifier name: **MICHAEL COLLINS**  
 License Number: **200698**  
 BCA Occupancy Class: **Class 1a(i) & 10a**  
 BCA Type of Construction: **NA**  
 Issue date: **04/09/2010**

*Michael Collins*

Certifier signature

Page 7 of 7



PROJECT:  
**Additions & Alterations  
 Block 4  
 Section 8  
 WARAMANGA**

CLIENT: <b>Cooper Residence</b>	DESIGNED: <b>AC</b>	DATE: <b>29-7-10</b>	JOB No:	REV:
	DRAWN: <b>AC</b>	Scale: <b>1:100@A3</b>	DRAWING STATUS: DEVELOPMENT APPLICATION	
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NOTE:  
 Connect 90mm UPVC storm water line to storm water tie.  
 Exact location of storm water tie to be confirmed by builder prior to construction.

Block boundaries & contours easements to be verified on site prior to construction.

Retaining wall heights to suit site conditions final height to be confirmed by builder.

SITE AREA: 781.57m<sup>2</sup>  
 Existing Living Area: 109.69m<sup>2</sup>  
 Existing Garage Area: 58.50m<sup>2</sup>  
 Total Living: 109.69m<sup>2</sup>

Max Plot Ratio: 50% - 390.79m<sup>2</sup>  
 ACHIEVING PLOT RATIO  
 21.52% - 160.19m<sup>2</sup>

Open Space Requirements:  
 60% site area less 50sqm required: 418.94m<sup>2</sup>  
 ACHIEVING: 621.38m<sup>2</sup>

10% of block area to have a minimum dimension of 6m required: 78.16m<sup>2</sup>  
 ACHIEVING: 270.79m<sup>2</sup>

Erosion & Sediment  
 "To comply with best practice guidelines prevent pollution from residential building sites, March 2006."


The development will comply with the ACT Environment Protection Authority, Environment Protection Guidelines for Construction and Land Development in the ACT, August 2007.

**PLAN ENDORSED  
 STORMWATER EASEMENT**

The information contained in this plan complies with TAMS requirements.

Joelle Bou-Jaoude  
 Compliance Officer  
 Territory and Municipal Services

A Failure to accurately locate Stormwater assets, Subsoil drains or street lighting assets prior to commencement could result in damage and costs which the property owner will be liable.

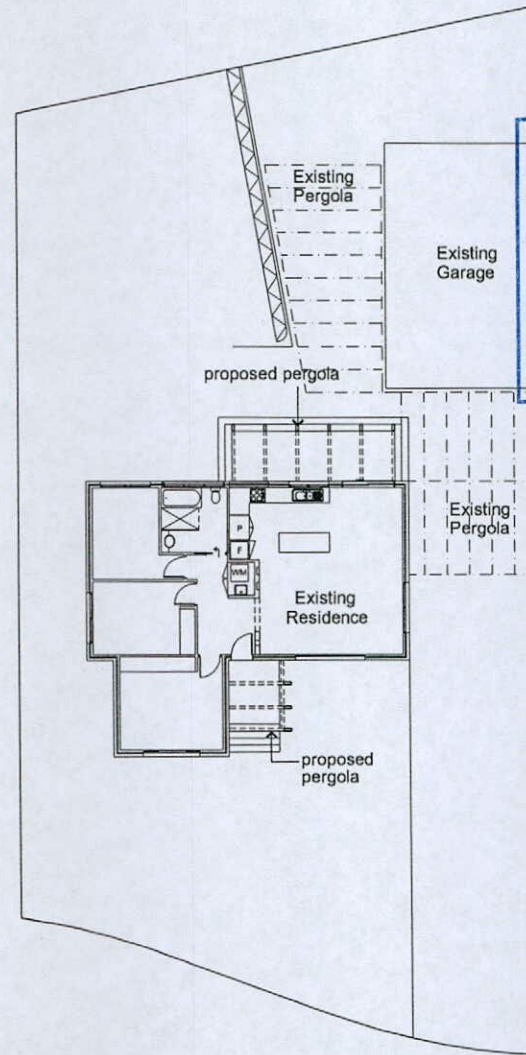

Plan No: 10471/A  
 09 SEP 2010  
 RECEIVED  
 ACT Planning & Land Authority

Site Plan.

PROJECT:  
 Additions & Alterations  
 Block 4  
 Section 8  
 WARAMANGA

CLIENT: Cooper Residence	DESIGNED: AC	DATE: 29-7-10	JOB No:	REV:
	DRAWN: AC	Scale: 1:200@A3	DRAWING STATUS: DEVELOPMENT APPLICATION	
DRAWING TITLE: SITE PLAN		DWG No: A001		
<small>© COPYRIGHT:        Reproduction of this whole or part of the document constitutes an infringement of copyright. The information, ideas and concepts contained in this document are confidential. The recipient(s) of this document shall be prohibited from such information, ideas and concepts to any person without the prior written consent of the copyright holder.</small>				

mm UPVC storm water  
n water tie.

Exact location of storm water tie to be confirmed by builder prior to construction.

Block boundaries & contours easements to be verified on site prior to construction.

Retaining wall heights to suit site conditions final height to be confirmed by builder.

SITE AREA: 781.57m<sup>2</sup>  
Existing Living Area: 109.69m<sup>2</sup>  
Existing Garage Area: 58.50m<sup>2</sup>  
Total Living: 109.69m<sup>2</sup>


Max Plot Ratio: 50% - 390.79m<sup>2</sup>  
ACHIEVING PLOT RATIO  
21.52% - 160.19m<sup>2</sup>

Open Space Requirements:  
60% site area less 50sqm  
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10% of block area to have a minimum dimension of 6m  
required: 78.16m<sup>2</sup>  
ACHIEVING: 270.79m<sup>2</sup>

Erosion & Sediment  
"To comply with best practice guidelines prevent pollution from residential building sites, March 2006."

The development will comply with the ACT Environment Protection Authority, Environment Protection Guidelines for Construction and Land Development in the ACT, August 2007.

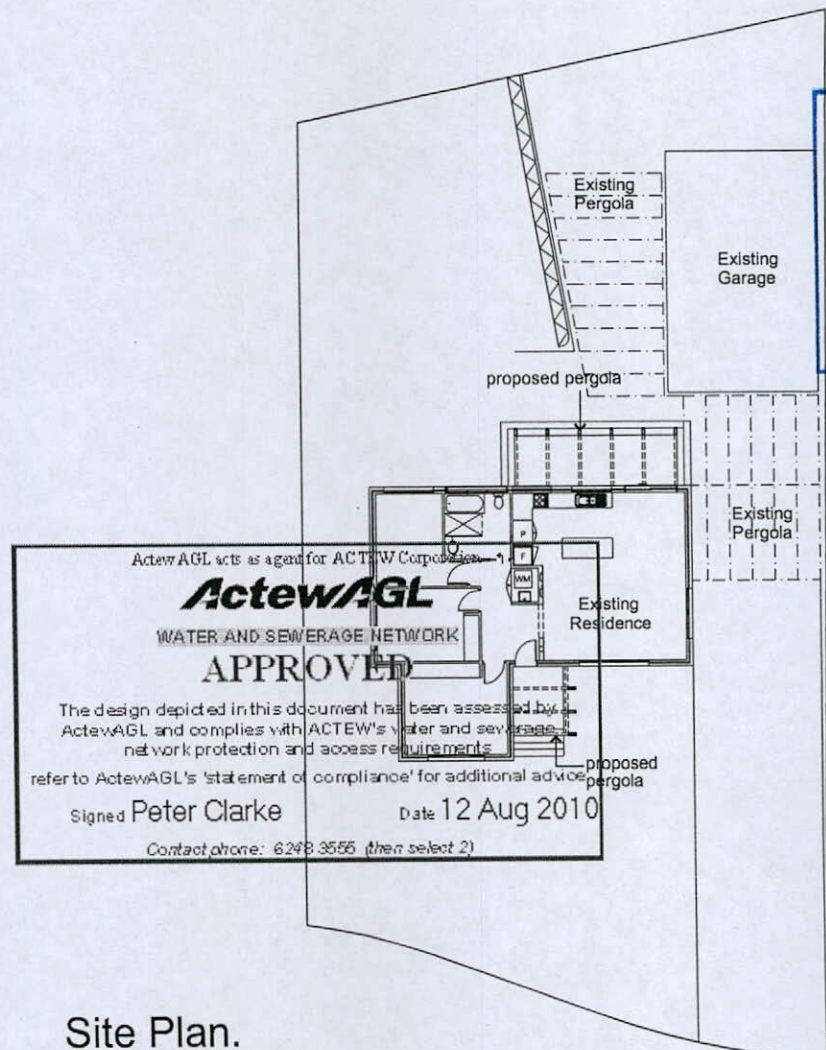

Plan No: 10471/A  
09 SEP 2010  
RECEIVED  
ACT Planning & Land Authority

Site Plan.



PROJECT:  
Additions & Alterations  
Block 4  
Section 8  
WARAMANGA



CLIENT: Cooper Residence	DESIGNED: AC	DATE: 29-7-10	JOB No:	REV:
	DRAWN: AC	Scale: 1:200@A3	DRAWING STATUS: DEVELOPMENT APPLICATION	
	DRAWING TITLE: SITE PLAN		DWG No: A001	
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**ActewAGL**

application number  
111658

Sheet  
3 of 7

Plan No: 104771/A  
09 SEP 2010  
RECEIVED  
ACT Planning & Land Authority

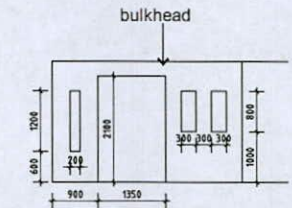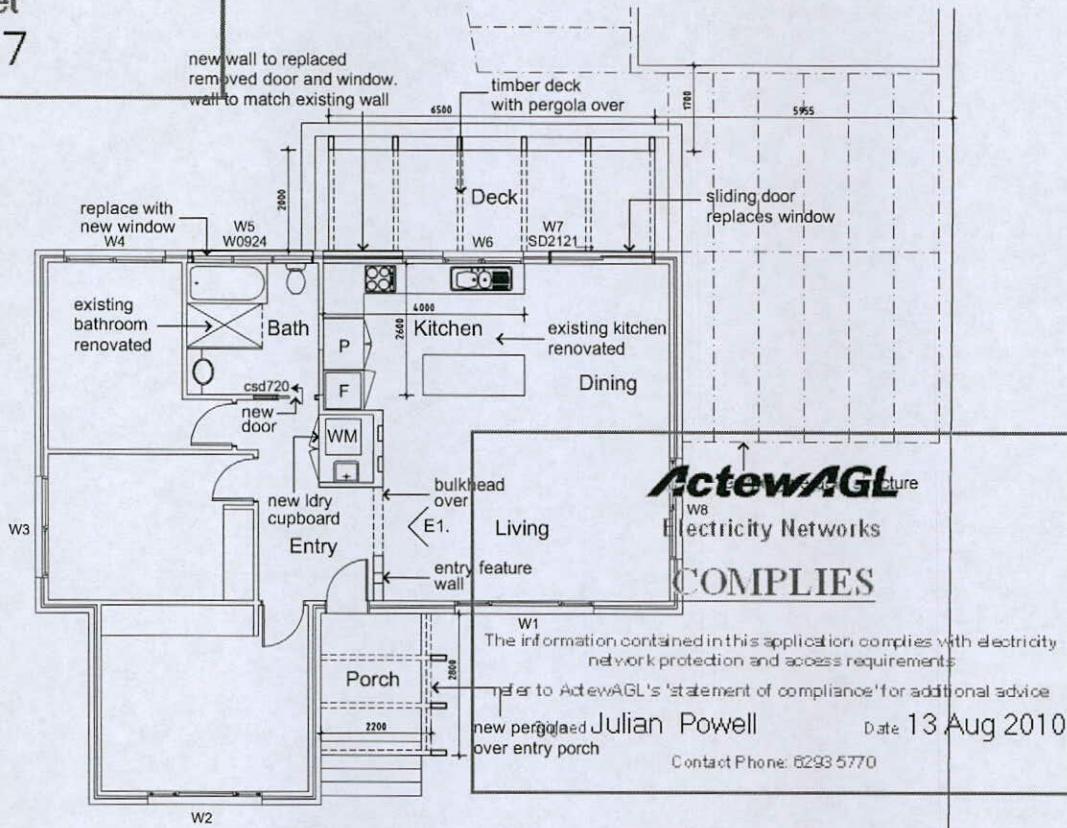

**ActewAGL** Electricity Networks  
**COMPLIES**

W1  
The information contained in this application complies with electricity network protection and access requirements  
refer to ActewAGL's 'statement of compliance' for additional advice

new pergola over entry porch

Julian Powell Date 13 Aug 2010  
Contact Phone: 6293 5770

4. 1.

Floor Plan.

NOTE:  
all dimensions to be checked & verified on site prior to any construction.

Where demolition work is carried out ensure that adequate structural support is provided to maintain the integrity of existing structure prior to removing any existing building element.

All materials to match existing  
Maintain cavity construction

The development will comply with the ACT Environment Protection Authority, Environment Protection Guidelines for Construction and Land Development in the ACT, August 2007.

PROJECT:  
Additions & Alterations  
Block 4  
Section 8  
WARAMANGA

CLIENT: Cooper Residence	DESIGNED: AC	DATE: 29-7-10	JOB No:	REV:
	DRAWN: AC	Scale: 1:100@A3	DRAWING STATUS: DEVELOPMENT APPLICATION	
© COPYRIGHT: Reproduction of this whole or part of the document constitutes an infringement of copyright. The information, ideas and concepts contained in this document are confidential. The recipient(s) of this document are prohibited from such information, ideas and concepts to any person without the prior written consent of the copyright holder.	DRAWING TITLE: FLOOR PLAN		DWG No: A100	

**PART A - PROJECT DETAILS**

Unit	Block	Section	Division (Suburb)	District	Jurisdiction
	4	8	WARAMANGA	WESTON CREEK	Australian Capital Territory

**PART B - WORKS REQUIRING BUILDING APPROVAL**

Item of building work to which this Building Approval relates:

Class of Occupancy	Nature of Work	Project Item Description	Other Description	Type Of Construction	Storeys	Area (m2)	Cost of Works (\$)
1a(l)	Other	SEE DESCRIPTION	secondary residence	NA	1	58.50	80506.00

Work relates to the following Development Application(s):

Development Application ID	Description
201323912	Merit -

**PART C - CERTIFIERS DECLARATION**

I declare that in issuing this building approval under section 28 of the Building Act 2004:

- I am satisfied on reasonable grounds that the plans meet each applicable approval requirement under section 29 and is not prevented from being issued under section 30 or section 30A
- I have supplied all documents as required under 3.3 Building Act 2004
- I have prepared a notice (building approval certificate) certifying what approval requirements apply to the application and why the building approval is not prevented from being issued; and
- I have given the building approval certificate to the applicant.

In performing services as a certifier in relation to the work detailed in this application I am not in breach of my entitlement to act as a certifier in accordance with the Building Act 2004.

Full Name	Address	License Number	Expiry Date
ASSET BUILDING CERTIFIERS PTY LTD	32 MCGIVERN CRESENT KAMBAH ACT 2902	20121120	6/11/2014

Date Issued : 12/11/2013

**NOTES**

**Utilities**

This application must also be accompanied by a Statement of Compliance from each relevant utility provider (for water, sewerage, electricity and stormwater) which confirms that the location and nature of earthworks, utility connections, proposed buildings, pavements and landscape features comply with utility standards, access provisions and asset clearance zones.

## General Notes

Comply with regulations and by-laws of authorities with jurisdiction over the works and including those relating to water supply, gas, sewerage, health and electricity. Give all notices and pay fees required by the authorities.

All work to comply with the Building Code of Australia and relevant Australian Standards and Local Building Regulations. Work shown or described on the drawings or in the schedule is to be carried out whether drawn and not specified or visa versa.

The requirements of regulations take precedence over the drawings. Written dimensions take precedence over scaled. Detail drawings take precedence over general drawings.

Check all dimensions on site before commencing construction or producing shop drawings or fabricating components.

NOTE: drawings of the existing, including ground lines are approximate and are for general information only and should be verified on site. Proposals: submit proposals for action to be taken with respect to existing services before starting this work.

Before practical completion, clean throughout, including interior and exterior surfaces exposed to view. Vacuum carpeted and soft surfaces. Clean debris from site, roofs, gutters, down pipes and drainage systems. Remove waste, surplus materials and rubbish from site. Builder to allow for drainage plan.

Concrete slabs and footings to AS2870-1998. All footings to be taken down to solid ground. Framing to AS1684-1999 'National timber framing code' Hardwood to AS3000. Tie downs and bracing to 'National timber framing code' and in accordance with local wind loading requirements. Lintels to truss manufacturers tables. Brickwork to AS3700 'SAA masonry' and AS 1640 'SAA brickwork code'. Structural steel to AS 1170 and AS4100. Termite protection to comply with AS1694 'Physical Barriers' and AS3660 'Appendix D' and to local building regulations. Smoke alarms to AS3786. Wet seal to AS3740. Lighting to comply with clause 3.12.5.5 of the BCA. Water heater in an hot water supply system to comply with clause 3.12.5.6 of the BCA


2000L water tank

## Verge Management Note

- no construction material to be stored on verges.
- no car parking or equipment parking on verges.
- no site sheds, storage sheds, site amenities or bill boards to be erected on verges.
- fence off existing trees to enclose the area:
  - beneath the extent of crown spread, or
  - along kerb, along property line and along driveway
- fencing is to be erected on commencement of site work and removed at completion of construction and commencement of verge restoration.
- the fence is to remain continuous throughout the project, except where approved service installation occurs.

## Sediment Fence Notes

- all erosion and sedimentation control measures, including revegetation and storage of soil and topsoil, shall be implemented to the standards of the soil conservation of nsw.
- all drainage works shall be constructed and stabilized as early as possible during development.
- sediment traps shall be constructed around all inlet pits, consisting of 300mm wide x 300mm deep trench.
- all sediment basins and traps shall be cleaned when the structures are at a maximum of 50% full of soil materials, including during the maintenance period.
- all disturbed areas shall be revegetated as soon as works are completed.
- soil and topsoil stockpiles shall be located away from drainage lines and areas where water may concentrate.
- filter shall be constructed by stretching a filter fabric (propex or approved equivalent) between posts at 3000mm cts.

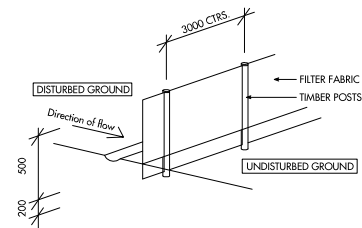

2 Sediment Fence Detail  
NTS

## ASSET BUILDING CERTIFIERS PTY LTD

Building certifiers, building code & fire safety consultants ACT & NSW

**BUILDING APPROVAL (BA)** issued under s 28 of the Building Act 2004 for this building work only at **WARAMANGA BLOCK 4 SECTION 8.**

Certifier Name: **ASSET BUILDING CERTIFIERS PTY LTD**

License Number: **20121120**


BCA Class: **1a(j)**

BCA Type of Construction: **NA**

Issue date: **12 November 2013**

*Michael Collins*

**ASSET BUILDING CERTIFIERS PTY LTD**

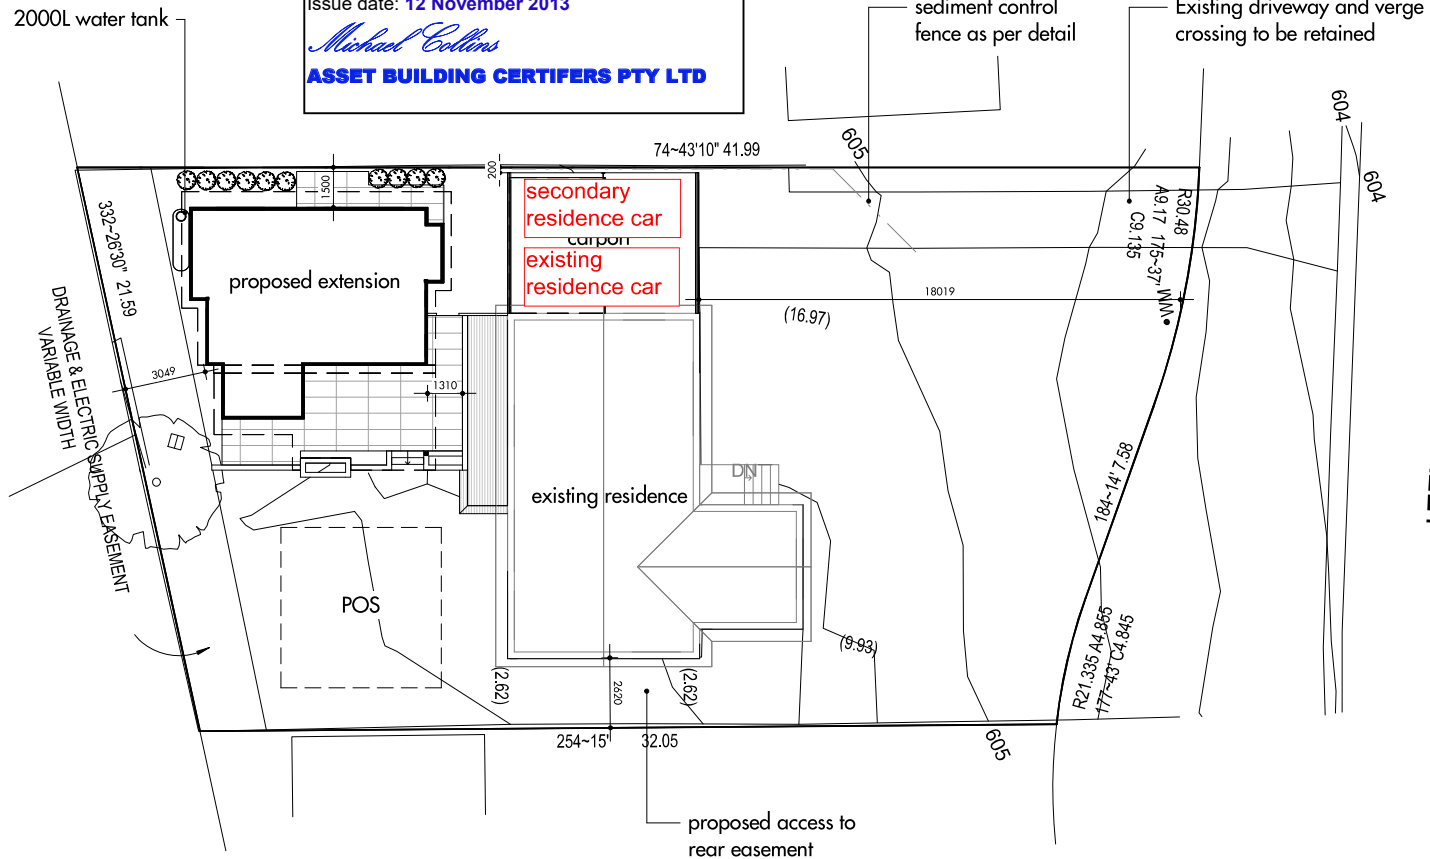

1 Site & Landscape Plan  
1 : 200@A3

## Area Analysis

site area	781.57 m <sup>2</sup>
existing residence	110.92 m <sup>2</sup>
proposed granny flat	58.55 m <sup>2</sup>
total floor area	169.46 m <sup>2</sup>
plot ratio	21.68%

Date	No.	Amendment	Code



MALARA STREET

PROJECT: Granny Flat

CLIENT: J. Cooper & C. McSkimming

ADDRESS: 34 Malara St  
Waramanga

DRAWING

Site & Landscape Plan

BLOCK/LOT: 4 SECTION/DP: 8

DATE: 8 Jul 2013 SCALE: As indicated

JOB NO: 1202 DRAWN: AK

DWG NO: A01 ISSUE:



PLANNING AND DEVELOPMENT ACT 2007  
**APPROVAL GRANTED**  
PURSUANT TO SECTION 165

Delegate name TARA MICHAEL  
Date 1/11/2013

all dimensions to stud frame (not to external cladding)

bathroom walls to be engineered to ensure future-fit of grab rails to AS 4299 'Adaptable Housing'

Glazing as per 2010 Glazing Calculations

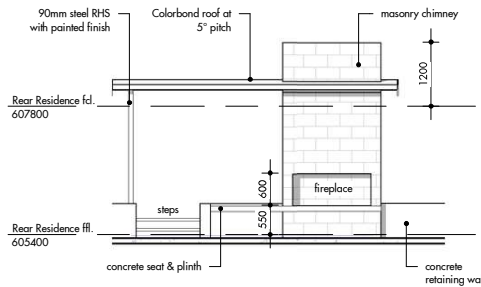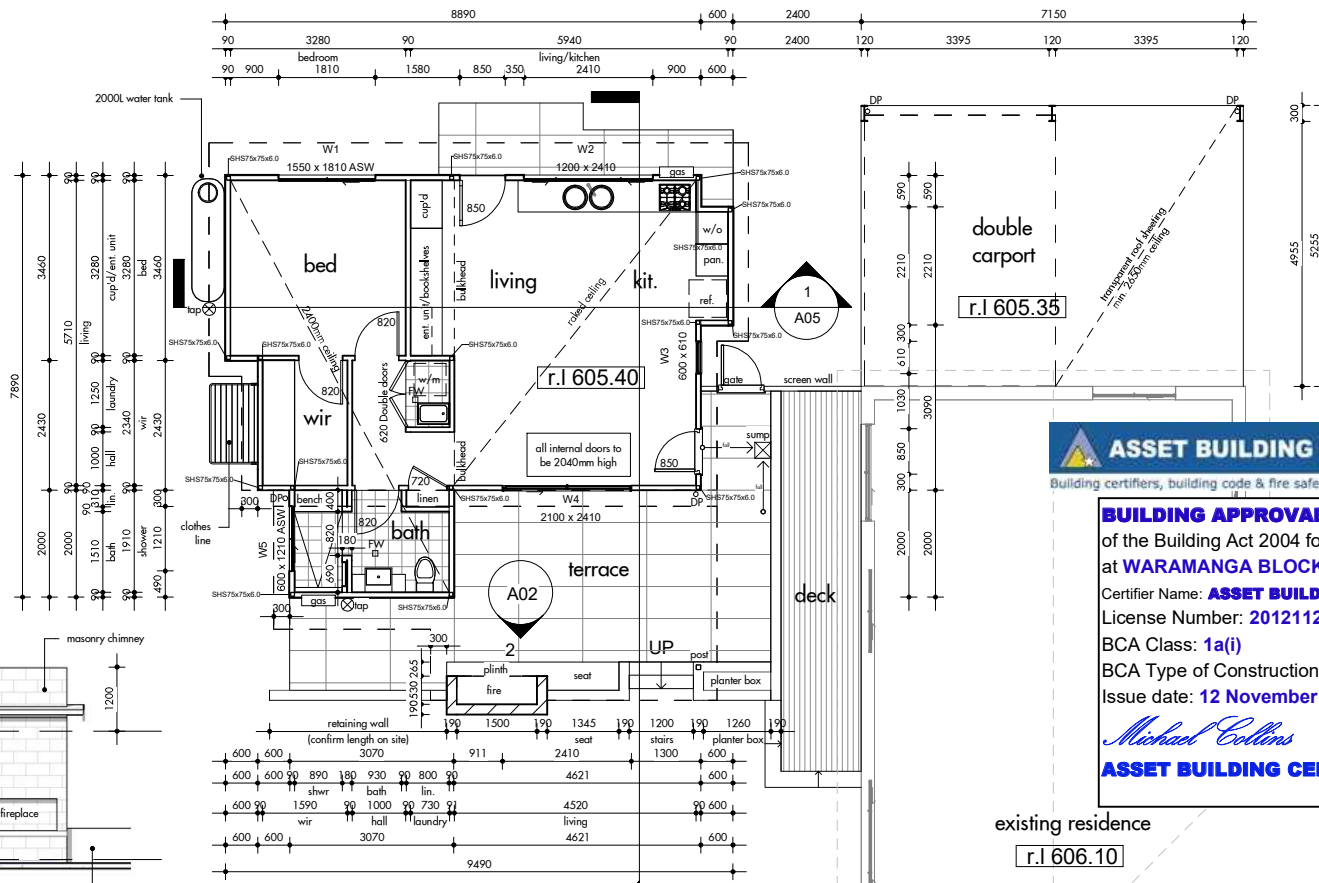

2 Fireplace Elevation  
 - 1 : 100@A3

1 Floor Plan  
 - 1 : 100@A3

**ASSET BUILDING CERTIFIERS PTY LTD**  
 Building certifiers, building code & fire safety consultants: ACT & NSW

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 Certifier Name: **ASSET BUILDING CERTIFIERS PTY LTD**  
 License Number: **20121120**  
 BCA Class: **1a(i)**  
 BCA Type of Construction: **NA**  
 Issue date: **12 November 2013**

*Michael Collins*  
**ASSET BUILDING CERTIFIERS PTY LTD**

Report from Cooper @ Waramanga - Glazing Calc 2012.xlsx printed 13/06/2013

**BCA VOLUME TWO GLAZING CALCULATOR (first issued with BCA 2010)**

Building name/description: **Cooper @ Waramanga - Block 4, Section 8** Climate zone: **7** C<sub>1</sub>: 5.488 C<sub>2</sub>: 0.189

Storey: **main floor** Floor Construction: **S9W** Area: **59m²** Wall insulation concession (not used): **No wall insulation concession used**

Area of glazing: **13.4m² (23% of area of storey)** ALLOWANCES: C<sub>1</sub> penalty: **5.5** C<sub>2</sub> x Area: **11.2**

GLAZING ELEMENTS, ORIENTATION, SIZE AND PERFORMANCE CHARACTERISTICS	Orientation	Size			Performance		SHADING		CALCULATION DATA			CALCULATED OUTCOMES - OK (if inputs are valid)			
		Facing sector	Height (m)	Width (m)	Total Area (m²)	U-Value (AIRC)	SHGC (AIRC)	P	H	Exposure	Area used (m²)	U-Value winter scope	SHGC x U-Value winter scope	Element share of allowance used	
1 W1 - TND-001-12	N	1.50	1.80	2.70	4.3	0.58	0.60	2.30	0.19	0.72	2.70	1.29	23% of 100%	1.1	23% of 39%
2 Door - TND-030-01	N	2.10	0.82	1.72	4.2	0.51	0.60	2.86	0.70	0.75	1.72	0.78	14% of 100%	0.7	15% of 39%
3 W2 - TND-001-12	N	1.20	2.40	2.88	4.3	0.58	0.60	1.96	0.15	0.69	2.88	1.33	24% of 100%	1.1	26% of 39%
4 W3 - TND-002-12	E	0.60	0.60	0.36	4.2	0.57	0.30	0.76	0.43	0.74	0.36	0.16	3% of 100%	0.2	4% of 39%
5 W4 - TND-017-11	E	2.10	2.40	5.04	3.0	0.59	3.86	2.40	1.63	0.32	5.04	1.63	32% of 100%	1.0	25% of 39%
6 W5 - TND-001-12	W	0.60	1.20	0.72	4.3	0.58	0.30	0.79	0.38	0.78	0.72	0.33	5% of 100%	0.3	7% of 39%

**IMPORTANT NOTICE AND DISCLAIMER IN RESPECT OF THE GLAZING CALCULATOR**  
 The Glazing Calculator has been developed by the ABCB to assist in developing a better understanding of glazing efficiency parameters. While the ABCB believes that the Glazing Calculator, if used correctly, will produce accurate results, it is provided "as is" and without any representation or warranty of any kind, including that it is fit for any purpose or of merchantable quality, or functions as intended or at all. Your use of the Glazing Calculator is entirely at your own risk and the ABCB accepts no liability of any kind.

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PLANNING AND DEVELOPMENT ACT 2007  
**APPROVAL GRANTED**  
 PURSUANT TO SECTION 165

Delegate name **TARA MICHAEL**  
 Date **1/11/2013**


Date	No.	Amendment	Code

**PlanitGreen**  
 PO BOX 5112  
 LYNEHAM ACT 2602  
 F: 6100 6130  
 M: 0439 494 121  
 W: planitgreen.net.au

PROJECT: **Granny Flat**  
 CLIENT: **J. Cooper & C. McSkimming**  
 ADDRESS: **34 Malara St Waramanga**  
 DRAWING: **Floor Plan**

BLOCK/LOT: <b>4</b>	SECTION/DP: <b>8</b>
DATE: <b>8 Jul 2013</b>	SCALE: <b>1 : 100</b>
JOB NO: <b>1202</b>	DRAWN: <b>AK</b>
DWG NO: <b>A02</b>	ISSUE: <b> </b>


Date	No.	Amendment	Code

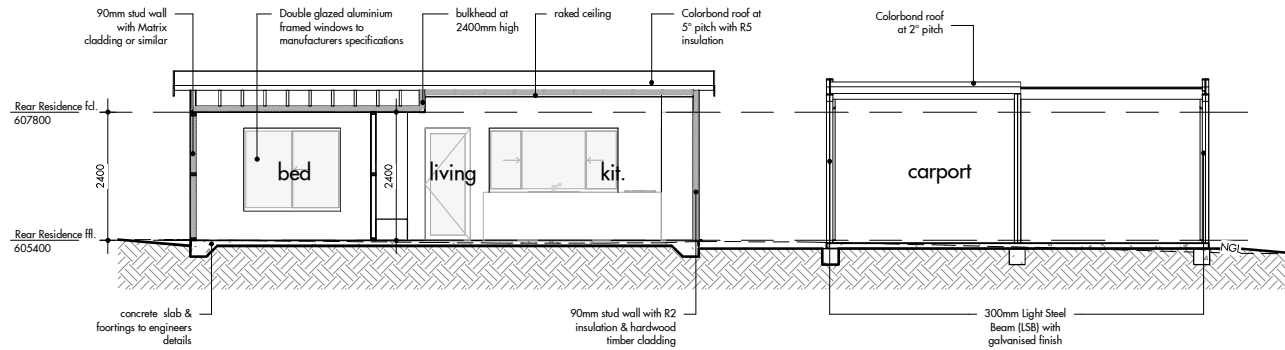

1 Section A-A  
 1 : 100@A3

**ASSET BUILDING CERTIFIERS PTY LTD**  
 Building certifiers, building code & fire safety consultants ACT & NSW

**BUILDING APPROVAL (BA)** issued under s 28 of the Building Act 2004 for this building work only at **WARAMANGA BLOCK 4 SECTION 8**.  
 Certifier Name: **ASSET BUILDING CERTIFIERS PTY LTD**  
 License Number: **20121120**  
 BCA Class: **1a(i)**  
 BCA Type of Construction: **NA**  
 Issue date: **12 November 2013**  
*Michael Collins*  
**ASSET BUILDING CERTIFIERS PTY LTD**

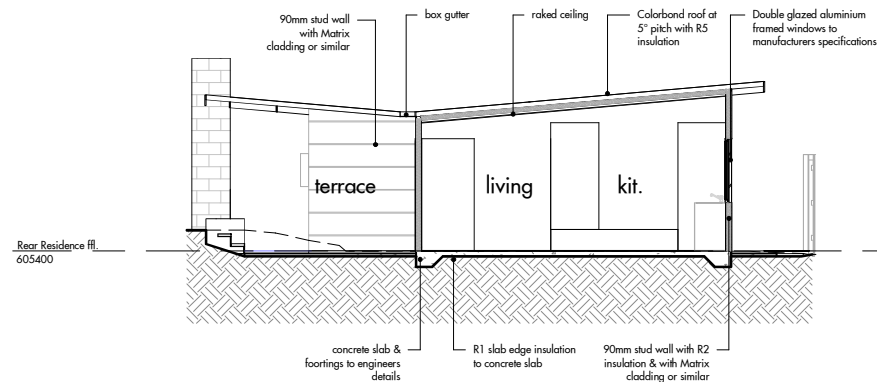

2 Section B-B  
 1 : 100@A3

PLANNING AND DEVELOPMENT ACT 2007  
**APPROVAL GRANTED**  
 PURSUANT TO SECTION 165  
 Delegate name TARA MICHAEL  
 Date 1/11/2013

**PlanitGreen**  
 PO BOX 5112  
 LYNEHAM ACT 2602  
 F: 6100 6130  
 M: 0439 494 121  
 W: planitgreen.net.au


PROJECT: Granny Flat  
 CLIENT: J. Cooper & C. McSkimming  
 ADDRESS: 34 Malara St Waramanga

DRAWING

Sections

BLOCK/LOT: 4	SECTION/DP: 8
DATE: 8 Jul 2013	SCALE: 1 : 100
JOB NO: 1202	DRAWN: AK
DWG NO: A05	ISSUE:


Date	No.	Amendment	Code

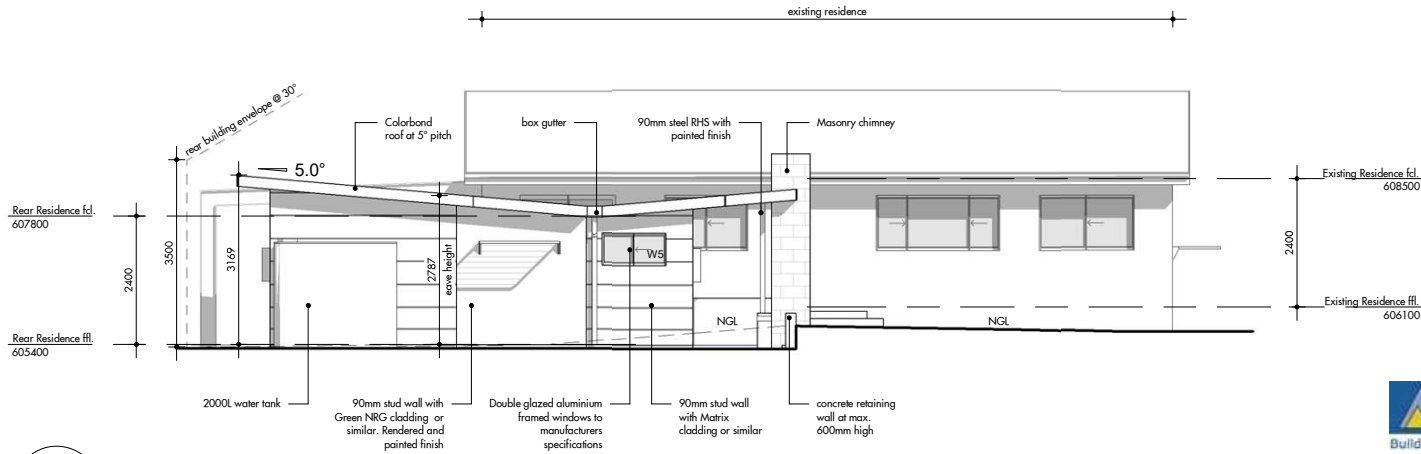

1 West Elevation  
 1 : 100@A3

**ASSET BUILDING CERTIFIERS PTY LTD**  
 Building certifiers, building code & fire safety consultants ACT & NSW

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 License Number: **20121120**  
 BCA Class: **1a(i)**  
 BCA Type of Construction: **NA**  
 Issue date: **12 November 2013**  
*Michael Collins*  
**ASSET BUILDING CERTIFIERS PTY LTD**

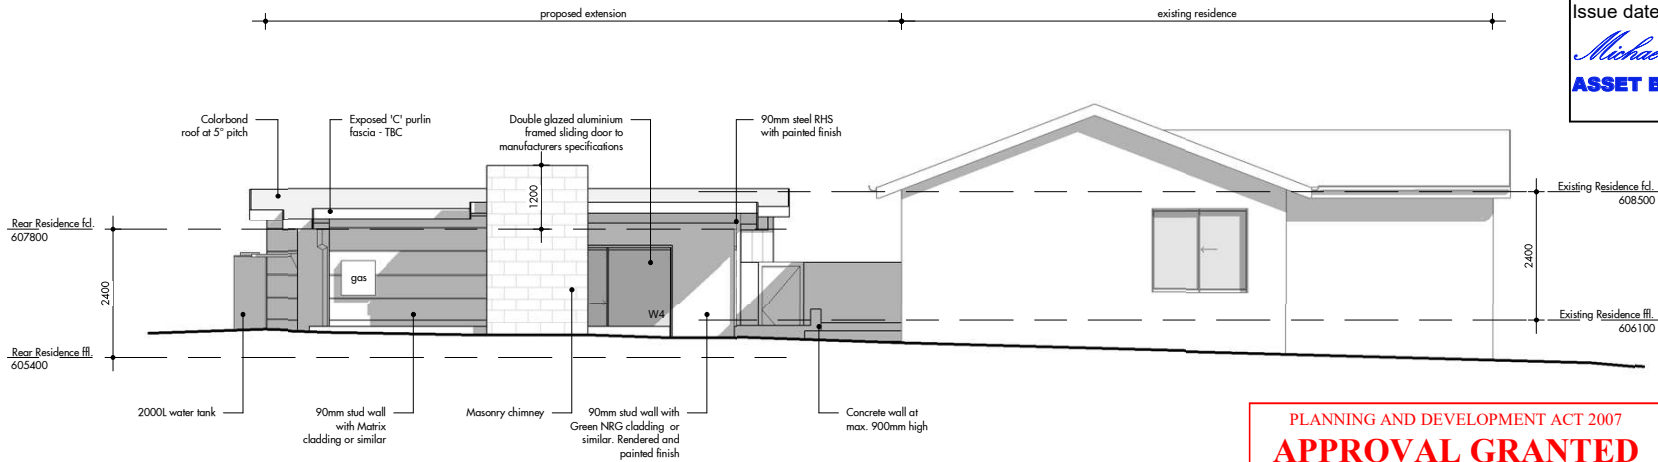

2 South Elevation  
 1 : 100@A3


**PlanitGreen**  
 PO BOX 5112  
 LYNEHAM ACT 2602  
 F: 6100 6130  
 M: 0439 494 121  
 W: planitgreen.net.au

PROJECT: **Granny Flat**  
 CLIENT: **J. Cooper & C. McSkimming**  
 ADDRESS: **34 Malara St Waramanga**

DRAWING Elevations


BLOCK/LOT: 4	SECTION/DP: Designer
DATE: 8 Jul 2013	SCALE: 1 : 100
JOB NO: 1202	DRAWN: AK
DWG NO: A03	ISSUE:

PLANNING AND DEVELOPMENT ACT 2007  
**APPROVAL GRANTED**  
 PURSUANT TO SECTION 165  
 Delegate name **TARA MICHAEL**  
 Date **1/11/2013**

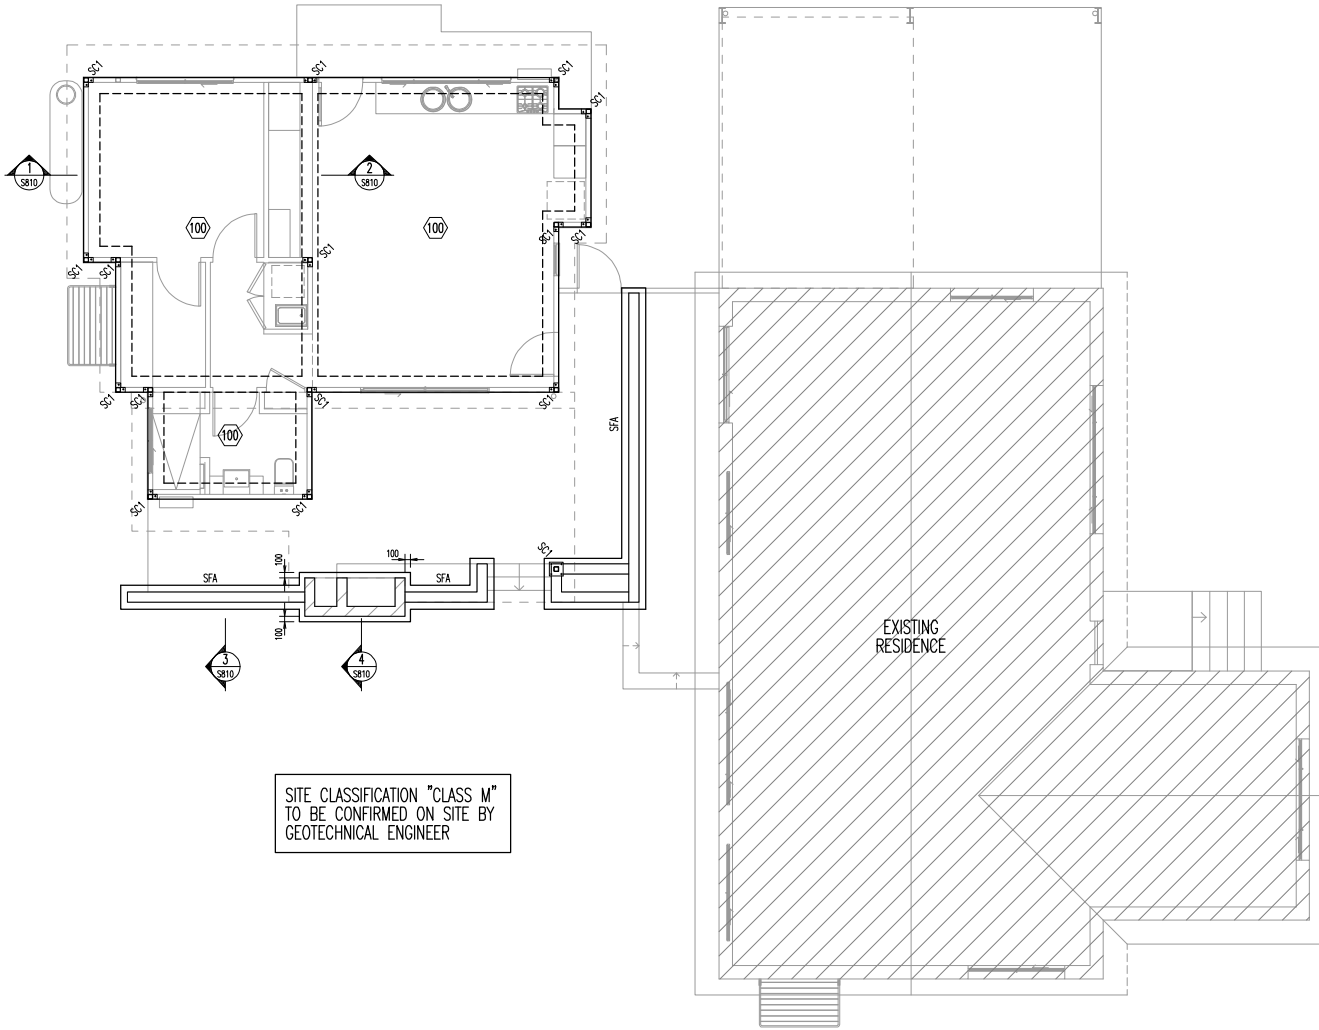

**GROUND FLOOR MARKING PLAN**  
SCALE 1:100 @ A3  
**100 SLAB ON GROUND U.N.O.**

- NOTES:**
- REFER TO DRAWING No S001 FOR CONSTRUCTION NOTES
  - REFER TO DRAWING No S001 FOR CONCRETE STRENGTHS
  - REFER TO S310 SERIES DRAWINGS FOR DESIGN LOADS
  - FOR BUILDING SETOUT AND DIMENSIONS REFER TO ARCHITECTS DRAWINGS
  - SLAB TO BE POURED ON 80mm MINIMUM BASECOURSE WITH SAND BLINDING AND VAPOR BARRIER
  - REINFORCE SLAB WITH SL72 FABRIC TOP THROUGHOUT UNO (30 COVER) LAP 300 WHERE REQUIRED
  - REFER TO PLAN AND SECTIONS FOR ADDITIONAL REINFORCEMENT
  - PROVIDE TRIMMER BARS AROUND ALL PENETRATIONS, COLUMNS, JOINT INTERSECTIONS AND RE-ENTRANT CORNERS. REFER TO TYPICAL SLAB ON GROUND TRIMMER DETAILS FOR REINFORCEMENT. ALL TRIMMER BARS TO BE LAD UNDER TOP REINFORCEMENT (FABRIC)
  - PROVIDE 10mm EXPANDING CORK FILLER AND 12mm DEEP MASTIC SEALANT AROUND ALL COLUMNS AND WALLS. REFER TO TYPICAL STRAIGHT JOINT FOR DETAILS
  - SLAB JOINTS ARE DENOTED AS FOLLOWS:  
— SJ — DENOTES SAWN JOINT. REFER TO TYPICAL DETAIL.  
— KJ — DENOTES KEVED CONSTRUCTION JOINT. REFER TO TYPICAL DETAIL.
  - ALL FALLS TO ARCHITECTS DETAILS
  - ENSURE ALL TILED SURFACES AND MASONRY WALLS ARE JOINTED ACROSS SAWN AND KEVED JOINTS
  - JOINT PATTERN MAY BE ALTERED TO SUIT CONSTRUCTION SEQUENCE. ADVISE ENGINEER OF PROPOSED CHANGES PRIOR TO POURING CONCRETE
  - ☞ DENOTES STRIP FOOTING TYPE. REFER TO TYPICAL DETAIL ON DRAWING S810.

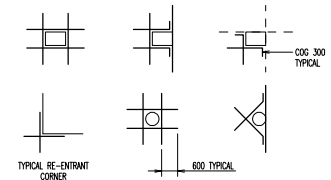

ALL TRIMMERS TO BE 1N12 U.N.O

**TYPICAL SLAB ON GROUND TRIMMER DETAILS**

PROVIDE TRIMMER BARS AT ALL COLUMNS, WALLS, PITS, FLOOR WASTES ETC THAT CAUSE A PENETRATION THROUGH THE SLAB

STEELWORK MEMBER SCHEDULE		
MARK	TYPE	SIZE
SC1	STEEL COLUMN	75 x 6.0 SHS
RC1	ROOF CHANNEL	150 PFC
FC1	FASCOA CHANNEL	150 PFC
GC1	GUTTER CHANNEL	150 PFC
XB	CROSS BRACING	12 DIA. ROD + TURNBUCKLE
P1	PURLIN	C150 15 AT 1200 MAX CENTRES

SITE CLASSIFICATION "CLASS M" TO BE CONFIRMED ON SITE BY GEOTECHNICAL ENGINEER

No	Revision	Date	No	Revision	Date	No	Revision	Date
1	ISSUE FOR INFORMATION	21.06.13						

Key Plan

1:1 SCALE  
0 1 2 3 4 5 6 7 8 9 10

**AWT**  
CONSTRUCTING ENGINEERS  
Page 65 of 80

CANBERRA  
UNIT 17, LEVEL 2  
118 BRINDABELLA CIRCUIT  
CANBERRA AIRPORT 2609  
Ph: (02) 8257 2614  
Fax: (02) 6257 1723  
www@awtcc.net.au

SYDNEY  
SUITE 301, 100 MOUNT ST  
NORTH SYDNEY NSW 2060  
Ph: (02) 9922 2466  
Fax: (02) 9922 3705  
Email: sydney@awtcc.net.au

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VERIFY ALL DIMENSIONS ON SITE BEFORE COMMENCING WORK  
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Client

Project

**PROPOSED GRANNY FLAT**  
34 MALARA ST.  
WARAMANGA A.C.T.

Drawn: R/JG  
Engineer: DCS  
Scale: 1:50 @ A1  
1:100 @ A3

Drawing Title

**GROUND FLOOR MARKING PLAN**

Job No: 139228  
Drawing No: S100  
Rev: 1

PLAN OF SANITARY DRAINAGE  
FOR

Owner NETWORK FINANCE LTD.  
LOTS 3 TO 6 incl. SECTION 8.  
DISTRICT WARAMANGA. A-C-T.

REFERENCE

- |                                 |                              |                                 |
|---------------------------------|------------------------------|---------------------------------|
| G.T. Gully Trap.                | S.P.D. Stoneware Pipe Drain. | E.V. Educt Vent.                |
| D.T. Disconnector Trap.         | I.C. Inspection Chamber.     | S.V.P. Soil Vent Pipe.          |
| G.I.T. Grease Interceptor Trap. | I.O. Inspection Opening.     | V.P. Ventilating Pipe.          |
| C.I.P. Cast Iron Pipe.          |                              | T.I.T. Triple Interceptor Trap. |


Scale — 40 feet = 1 inch

All work to be executed in accordance with the Canberra Sewerage and Water Supply Regulations.  
 This plan to be read in conjunction with the approved architectural plans and specifications.

NOTES:—Drains to be laid shown in blue lines. Existing drains shown in green lines.


FIXTURES

- No. 1. Water Closet.
- „ 2. Bath.
- „ 3. Shower.
- „ 4. Lav. Basin.
- „ 5. Sink.
- „ 6. Trough.
- „ 7. Washing Machine.

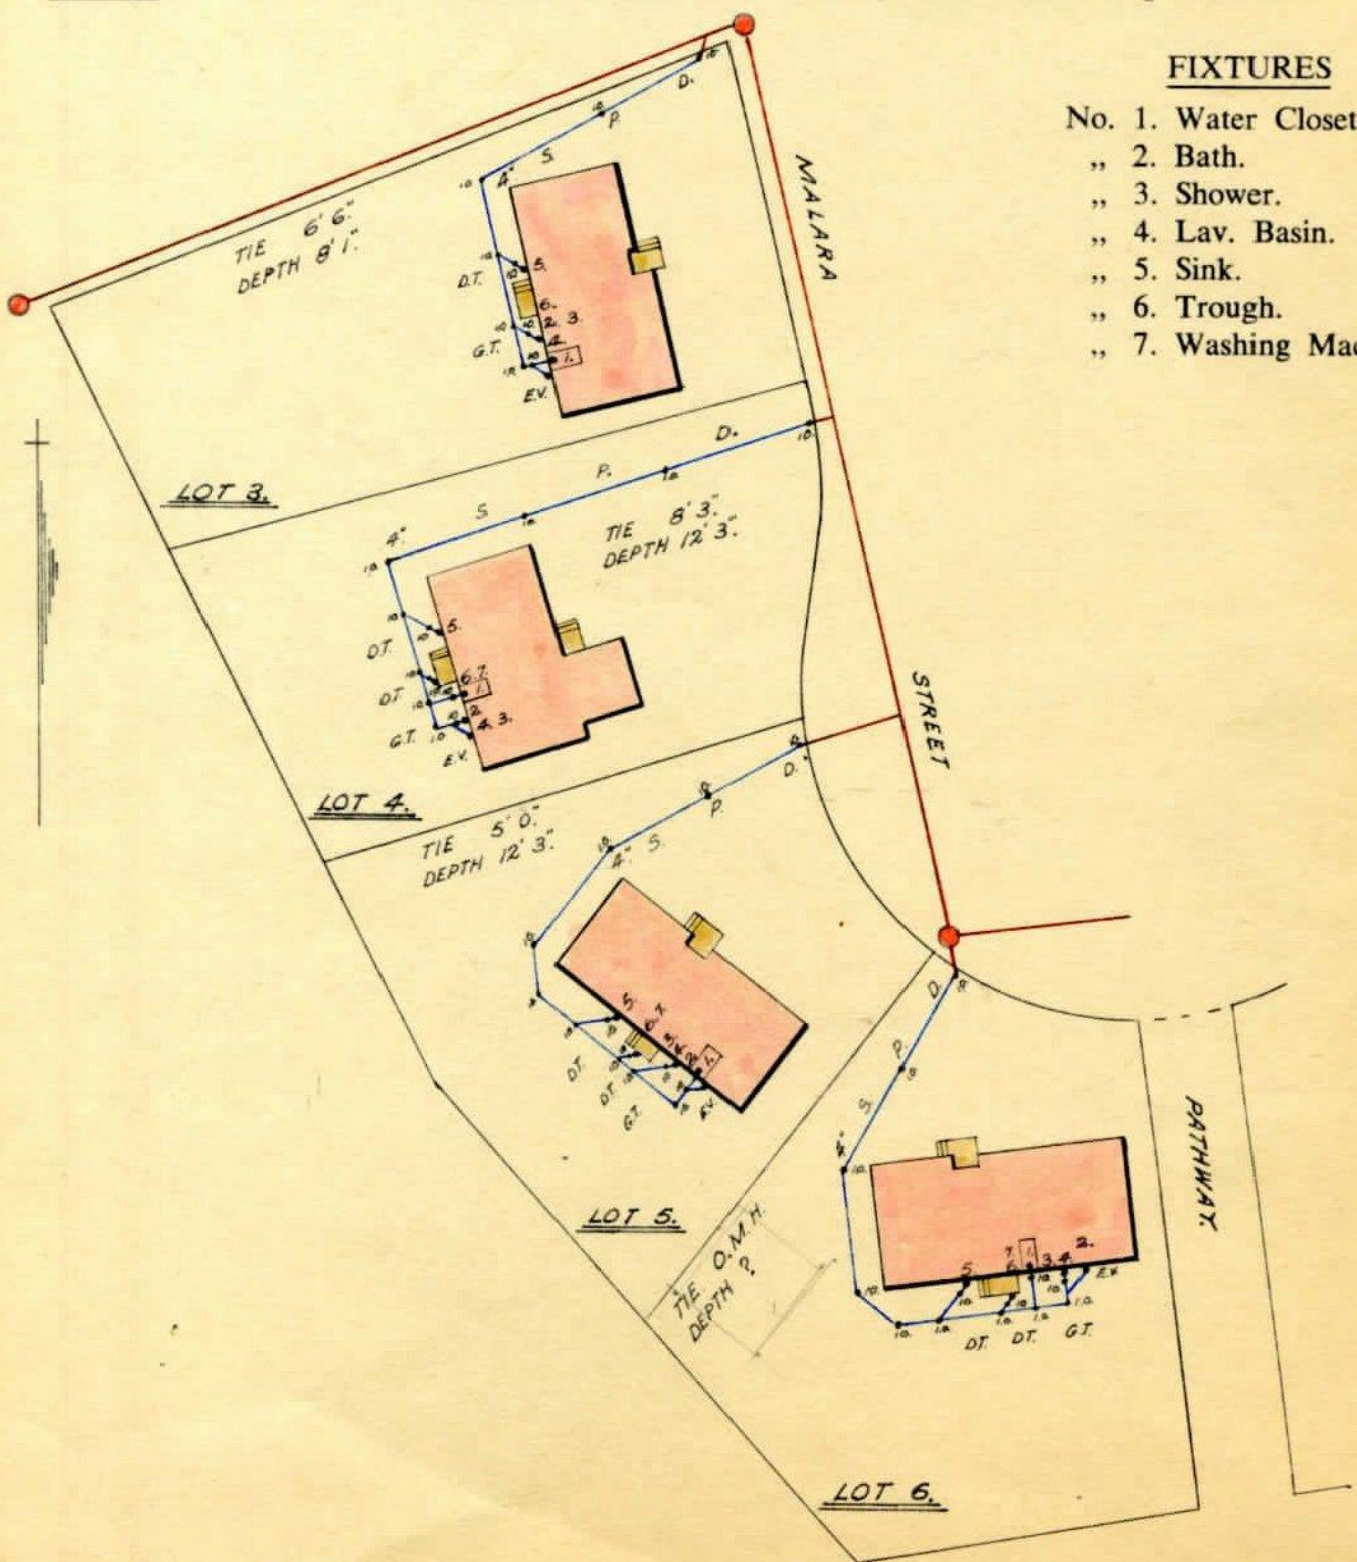

Designed by M. McNALLY, A.R.S.H.(LOND.)

*[Signature]*  
 Sewerage Engineer, 16/12/1965

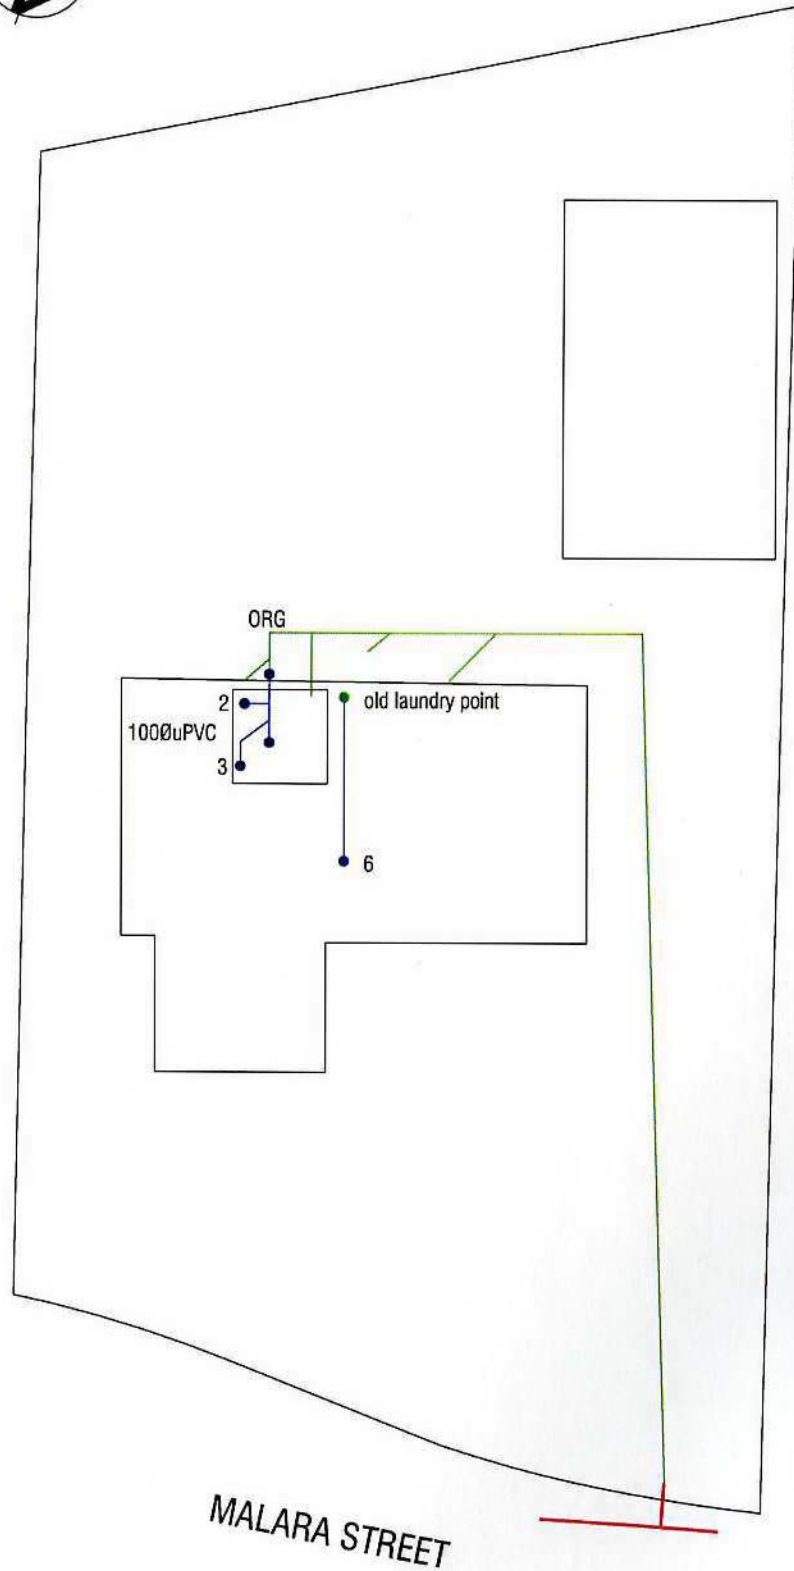

DRAINAGE PLAN No. 15230  
**PLAN OF SANITARY DRAINAGE**

**Owner COOPER**  
**Block 4 Section 8 WARRAMANGA**

All work must be carried out in conformity with the  
 Canberra Sewerage and Water Supply Regulations.

DESIGNED TO AS 3500

FIXTURES	Reference
1. WATER CLOSET =	ORG= Overflow Relief Gully
2. BATH = 1	EV= Educt Vent
3. BASIN = 1	IV= Induct Vent
4. SHOWER = 1	GT= Gully Trap
5. SINK =	uPVC= Unplasticised Polyvinyl Chloride
6. LAUNDRY = 1	JU= Jump Up
7. URINAL =	DT= Disconnecter Trap
8. CLEANERS SINK =	FW= Floor Waste
9. BIDET =	VP= Vent Pipe
	EJ= Expansion Joint
	SVP= Soil Vent Pipe
	IS= Inspection Shaft
	SPD= Stoneware Pipe Drain
	VCP= Vitrified Clay Pipe
	CIP= Cast Iron Pipe
	IO= Inspection Opening
	M.H.= Man Hole
	TD= Tundish
	TTD= Trapped Tundish
	BT= Bucket Trap
	RV= Reflux Valve

1. Drains to be laid shown in BLUE lines
2. Existing drains shown in GREEN lines.
3. Existing drains X'ed in RED to be abolished to approval.
4. Drains to be supported on or from solid ground.
5. Copper pipes to be in accordance with AS.1432-1973 table 2 Type B tubes.
6. Unplasticised Polyvinyl Chloride pipe drains (UPVC) including stacks to be constructed in accordance with AS.2032-1977, and the Canberra Codes of Practice.
7. Drains under Buildings must be retested. If test fails then old drain must be replaced using either RRJVCP or UPVC pipe material.
8. Connection to existing main/manhole to be made by A.C.T.E.W. at Contractor's expense.
9. Sewer branch to be located on site before any work is commenced.
10. This plan to be read in conjunction with approved Architectural plans and Specifications.
11. ORG levels to be in accordance with AS3500.2 Clause 4.6.6.6 and 4.6.6.7
12. I.S. at Property boundary is to be raised to Ground Level in accordance with Plumbing Note No. 3
13. Provide and install approved fire stop collars to all UPVC penetrations of fire rated walls and floors.
14. Provide tempered water to ablutionary fixtures as required by A.S.3500
15. All drains 1000 uPVC unless otherwise stated.

Drawn & Designed by :- John Hunt  
 Act Now Drainage Plans  
 85 Rowe Place Phillip A.C.T. 2606  
 Mobile 0412 623690 Ph./Fax 62867709

***Work As Executed***

DATE 22 / 11 / 11  
 A Ins

# Energy Efficiency Rating



## UNDERSTANDING YOUR ENERGY EFFICIENCY RATING (EER)

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An energy efficiency rating (EER) is a rating used to identify the energy efficiency of homes in the ACT.

The Civil Law (Sale of Residential Property) Act 2003 requires all homes being sold in the ACT to carry an energy efficiency rating (EER). This enables owners and buyers to compare a home's passive energy performance characteristics with others for sale in the Territory.

In the ACT, established homes are assessed using 1st generation software, and can achieve **0 to 6 stars** in the rating scheme.

Houses with a higher EER are more cost and energy efficient, use less energy for heating and cooling, generate lower greenhouse gas emissions, and are more comfortable.

### **What information is taken into account when assessing my homes energy efficiency?**

- Layout of the home
- Construction of its roof, walls, windows, and floor
- Wall, floor, and ceiling insulations
- Orientation of windows and shading of the sun's path and local breezes
- Influence of the local climate
- Air leakages

### **What information is not applicable when assessing my homes energy efficiency?**

- Heating and cooling
- Hot water systems
- Lighting systems and appliances
- Solar panels

### **How can I improve my energy efficiency rating?**

Your energy efficiency report will include a list of design options (unless it's already achieved the maximum rating of 6 stars). This will outline the improvements that can be made to gain additional points and increase the overall star rating of your home.

### **When I built my home, I was provided with a 10-star energy rating. Why has this decreased?**

The ACT Government has two software systems in place to generate energy efficiency ratings:

1. Established homes: An on site assessment using 1st generation software. A maximum of 6 stars can be achieved.
2. Brand new homes: A computer based assessment using 2nd generation software. A maximum of 10 stars can be achieved.

If you hold an energy efficiency rating that exceeds 6 stars, it is a 2nd generation EER and would have been provided when your home was brand new.

When assessing a home's energy efficiency for the purpose of sale, property inspection companies are required to use 1st generation software, which will achieve a maximum of 6 stars.

# FirstRate Report



**YOUR HOUSE ENERGY RATING IS:** ★★☆☆☆  
in Climate: 24

**4 STARS**

**SCORE: -5 POINTS**


**Name:** McSkimming

**Ref No:** 68451

**House Title:** Block 4 Section 8 WARAMANGA

**Date:** 26-02-2026


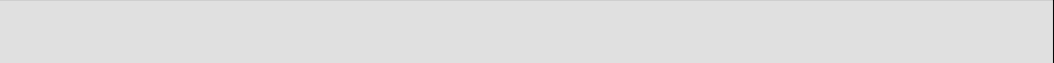
**Address:** 34 Malara St, Waramanga ACT 2611

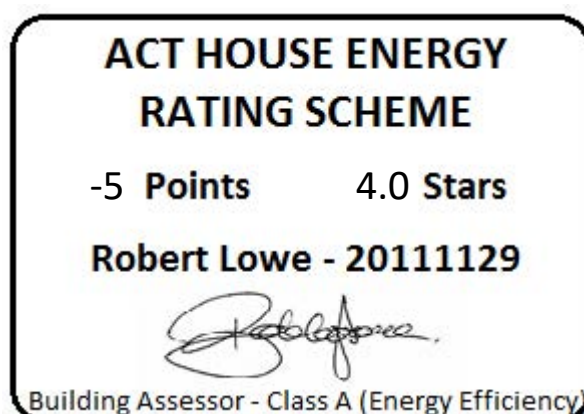

This rating only applies to the floor plan, construction details, orientation and climate as submitted and included in the attached Rating Summary. Changes to any of these could affect the rating.

## IMPROVING YOUR RATING

The table below shows the current rating of your house and its potential for improvement.

Star Rating	POOR			AVERAGE				GOOD				V. GOOD
	0 Star	★	★★	★★★	★★★★	★★★★★	★★★★★★	★★★★★★★	★★★★★★★★	★★★★★★★★★	★★★★★★★★★★	
Point Score	-71	-70	-46	-45	-26	-25	-11	-10	4	5	16	17
Current	-5											
Potential	26											

Incorporating these design options will add the additional points required to achieve the potential rating shown in the table. Each point represents about a 1% change in energy efficiency. This list is only a guide to the range of options that could be used.

### Design options

### Additional points

Change added floor insulation	R 2.5	9
Change glass to Double Glazing	100 %	9
Change curtain to	Heavy Drapes & Pelmets	13

## ORIENTATION

Orientation is one of the key factors which influences energy efficiency. This dwelling will achieve different scores and star ratings for different orientations.

<b>Current Rating</b>	<b>-5</b>	<b>★★★★</b>
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Largest windows in the dwelling;

**Direction : ENE**

**Area : 9 m<sup>2</sup>**

The table below shows the total score for the dwelling when these windows face the direction indicated.

**Note that obstructions overshadowing windows have been removed from all windows in these ratings to allow better comparisons to be made between orientations.**

<b>ORIENTATION</b>	<b>POINT SCORE</b>	<b>STAR RATING</b>
<b>1. North East</b>	<b>-3</b>	<b>★★★★</b>
<b>2. East</b>	<b>-3</b>	<b>★★★★</b>
<b>3. South East</b>	<b>-3</b>	<b>★★★★</b>
<b>4. South</b>	<b>0</b>	<b>★★★★☆</b>
<b>5. South West</b>	<b>-5</b>	<b>★★★★</b>
<b>6. West</b>	<b>-7</b>	<b>★★★★</b>
<b>7. North West</b>	<b>-8</b>	<b>★★★★</b>
<b>8. North</b>	<b>-2</b>	<b>★★★★</b>

FirstRate Mode
Climate: 24

**RATING SUMMARY for: Block 4 Section 8 WARAMANGA, 34 Malara St, Waramanga ACT 2611,**

Assessor's Name:

Net Conditioned Floor Area: 90.6 m<sup>2</sup>

			Points		
Feature	Winter	Summer	Total		
<b>CEILING</b>	<b>4</b>	<b>1</b>	<b>4</b>		
Surface Area: 0	Insulation: 4				
<b>WALL</b>	<b>-2</b>	<b>1</b>	<b>-1</b>		
Surface Area: -5	Insulation: 4	Mass: 0			
<b>FLOOR</b>	<b>-2</b>	<b>0</b>	<b>-2</b>		
Surface Area: 0	Insulation: -3	Mass: 0			
<b>AIR LEAKAGE (Percentage of score shown for each element)</b>	<b>6</b>	<b>0</b>	<b>5</b>		
Fire Place 0 %	Vented Skylights 0 %				
Fixed Vents 0 %	Windows 49 %				
Exhaust Fans 0 %	Doors 0 %				
Down Lights 0 %	Gaps (around frames) 51 %				
<b>DESIGN FEATURES</b>	<b>0</b>	<b>1</b>	<b>1</b>		
Cross Ventilation 1					
<b>ROOF GLAZING</b>	<b>0</b>	<b>0</b>	<b>0</b>		
Winter Gain 0	Winter Loss 0				

<b>WINDOWS</b>							<b>-9</b>	<b>-21</b>	<b>-30</b>
Window Direction	Area		Point Scores				Total		
	m2	%NCFA	Winter* Loss	Winter Gain	Summer Gain				
<b>ENE</b>	9	10%	-17	19	-8	-6			
<b>SSE</b>	1	1%	-1	1	0	-1			
<b>WSW</b>	10	12%	-20	9	-11	-21			
<b>NNW</b>	2	2%	-5	6	-2	-1			
<b>Total</b>	<b>22</b>	<b>24%</b>	<b>-44</b>	<b>35</b>	<b>-21</b>	<b>-30</b>			

\* Air movement over glazing can significantly increase winter heat losses. SEAV recommends heating/cooling duct outlets be positioned to avoid air movement across glass or use deflectors to direct air away from glass.

The contribution of heavyweight materials to the window score is -2 points

			Winter	Summer	Total
<b>RATING</b>	<b>★★★★</b>	<b>SCORE</b>	<b>-3</b>	<b>-19</b>	<b>-5*</b>

\* includes 18 points from Area Adjustment

# Detailed House Data

## House Details

ClientName McSkimming  
HouseTitle Block 4 Section 8 WARAMANGA  
StreetAddress 34 Malara St, Waramanga ACT 2611  
FileCreated 26-02-2026

## Climate Details

State  
Town Canberra  
Postcode 2600  
Zone 24

## Floor Details

ID	Construction	Sub Floor	Upper	Shared	Foil	Carpet	Ins RValue	Area
1	Timber	Enclosed	No	No	No	Carp	R0.0	77.8m <sup>2</sup>
2	Timber	Enclosed	No	No	No	Tiles	R0.0	24.0m <sup>2</sup>

## Wall Details

ID	Construction	Shared	Ins RValue	Length	Height
1	Brick Veneer	No	R1.5	44.9m	2.4m

## Ceiling Details

ID	Construction	Shared	Foil	Ins RValue	Area
1	Attic - Standard	No	No	R3.5	101.8m <sup>2</sup>

## Window Details

ID	Dir	Height	Width	Utility	Glass	Frame	Curtain	Blind	Fixed & Adj Eave	Fixed Eave	Head to Eave
1	ENE	1.8m	2.2m	No	SG	ALIMPR	HB	No	0.1m	0.1m	0.0m
2	ENE	1.8m	2.6m	No	SG	ALIMPR	HB	No	0.7m	0.7m	0.1m
3	NNW	1.4m	1.5m	No	SG	ALSTD	HB	No	0.1m	0.1m	0.0m
4	WSW	2.2m	2.2m	No	SG	ALIMPR	VB	No	0.7m	0.7m	0.1m
5	WSW	1.0m	1.5m	No	SG	ALIMPR	VB	No	0.7m	0.7m	0.1m
6	WSW	1.0m	2.3m	Yes	SG	ALIMPR	NC	No	0.7m	0.7m	0.1m
7	WSW	1.0m	1.8m	No	SG	ALIMPR	HB	No	0.7m	0.7m	0.1m
8	SSE	0.4m	1.8m	No	SG	ALIMPR	HB	No	0.7m	0.7m	1.0m

## Window Shading Details

ID	Dir	Height	Width	Obst Height	Obst Dist	Obst Width	Obst Offset	LShape Left Fin	LShape Left Off	LShape Right Fin	LShape Right Off
<b>No shaded windows</b>											

## Zoning Details

Is there Cross Flow Ventilation ? Good

## Air Leakage Details

Location Suburban  
Is there More than One Storey ? No  
Is the Entry open to the Living Area ? No  
Area of Heavyweight Mass 0m<sup>2</sup>  
Area of Lightweight Mass 0m<sup>2</sup>

	Sealed	UnSealed
Chimneys	0	0
Vents	0	0
Fans	0	0

Downlights	0	0
Skylights	0	0
Utility Doors	0	0
External Doors	0	0

Unflued Gas Heaters	0
Percentage of Windows Sealed	0%
Windows - Average Gap	Small
External Doors - Average Gap	Small
Gaps & Cracks Sealed	No

# Insurance Certificates & Tax Invoice



# If a home was built before 1990 it may contain dangerous asbestos material


Identify where asbestos materials might be. Five common places are:



- 1.** Exterior  
roof sheeting, gutters, downpipes,  
ridge capping, eaves, cladding,  
electrical switchboards



- 5.** Building cavities  
A small number of homes may still contain  
loose fill asbestos insulation in the roof  
cavity, wall cavities or sub-floor space

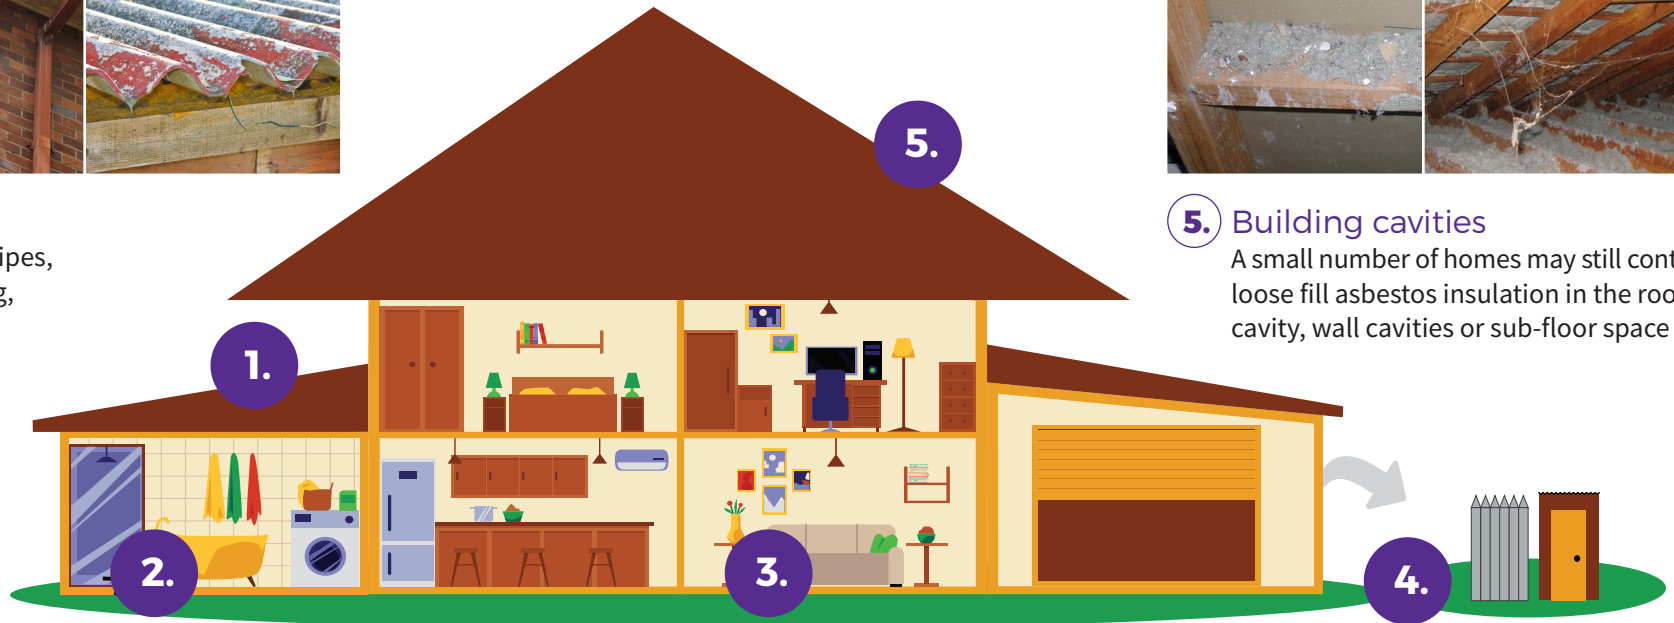

- 2.** Wet areas - bathroom, laundry and kitchen  
wall and ceiling panels, vinyl floor tiles, backing for wall tiles  
and splashbacks, hot water pipe insulation



- 3.** Internal areas  
wall and ceiling panels, carpet underlay,  
textured panels, insulation in domestic  
heaters



- 4.** Backyard  
fences, sheds, garages, carports, dog kennels, buried or  
dumped waste, letterboxes, swimming pools

# If a home was built before 1990 it may contain dangerous asbestos material

## Assess the risk

A licensed asbestos assessor can help identify asbestos in your home and its condition.

### Asbestos materials become dangerous when:



Broken or in poor condition



Damaged accidentally



Disturbed during renovation or repairs



Loose fill asbestos insulation



## Manage asbestos safely

- Monitor the condition of asbestos in your home
- Inform tradespeople of locations of asbestos in your home
- Avoid disturbing or damaging asbestos if working on your home
- Engage a licensed asbestos removalist to remove asbestos

If you suspect your home contains loose fill asbestos insulation, contact Access Canberra

## Pest Controllers Combined Liability Certificate of Currency

The Policy below is current until 4.00pm on the expiry date shown below

<b>INSURED:</b>	ACT Property Inspections Pty Ltd
<b>BUSINESS DESCRIPTION:</b>	General Pest & Weed Control Timber Pest Inspections Termite Barrier Installations Pre-Purchase House Pest Inspections Building Inspections (Non Pest Related) Energy Efficiency Ratings Compliance Reports
<b>POLICY REFERENCE:</b>	09A349653PLB
<b>PERIOD OF INSURANCE:</b>	From: 4.00pm on 30/03/2025 To: 4.00pm on 30/03/2026
<b>POLICY CLASS:</b>	Pest Controllers Combined Liability
<b>SUMS INSURED:</b>	<b>Section 1: General Public &amp; Products Liability</b>  <b>\$20,000,000</b> Our maximum liability in respect of any claim or series of claims for Personal Injury, Property Damage or Advertising Liability caused by or arising out of any one occurrence; and  <b>\$20,000,000</b> Our total aggregate liability during any one period of insurance for all claims arising out of Your Product  <b>Section 2: Professional Indemnity</b>  <b>\$5,000,000</b> Our maximum liability in respect of any Claim or any series of Claims inclusive of costs and expenses.  <b>\$10,000,000</b> Our total aggregate liability for all Claims inclusive of costs and expenses.

This Certificate of Currency is subject to the Policy Documentation to be read in conjunction with the Definitions, Conditions and Exclusions in the Pest Controllers Combined Liability Insurance Policy.

Date Issued: 28 March 2025



**ACT  
PROPERTY  
INSPECTIONS**

# TAX INVOICE

Catherine Jane McSkimming  
34 Malara St  
WARAMANGA ACT 2611  
AUSTRALIA

**Invoice Date**  
18 Feb 2026

**Invoice Number**  
INV-68451

ACT Property Inspections  
(02) 6232 4540  
Unit 1, 33 Altree Ct  
PHILLIP ACT 2606  
ABN: 33 600 397 466

Description	Quantity	Unit Price	GST	Amount AUD
ACTPLA Fees - No GST	1.00	186.70	GST Free	186.70
Property Report	1.00	1,475.73	10%	1,475.73
Energy Efficiency Report (Complimentary)	1.00	0.00		0.00
Deferred Payment (Complimentary)	1.00	0.00		0.00
			Subtotal	1,662.43
			TOTAL GST 10%	147.57
			<b>TOTAL AUD</b>	<b>1,810.00</b>

## Due Date: 17 Aug 2026

Payment terms – Deferred payment account. This account should be paid in full within 14 days on the earlier of:

- (a) Settlement of the property
- (b) If the Property has not been listed for sale within 3 months of the Property Inspection Date
- (c) If the property is no longer listed for sale
- (d) 180 days after the Property Inspection Date

Please pay within the payment terms to avoid the Deferred Payment Fee. Note: all bank/legal fees incurred in obtaining payment will be the customer's responsibility

### Payment Options

Pexa : please quote the invoice number as the reference

Direct Deposit : BSB: 012084 Account Number: 194679655

Account Name: ACT Property Inspections Pty Ltd

Please reference your name and invoice number

Cheques : please make payable to ACT Property Inspections Pty Ltd

[View and pay online now](#)